DA: PROPOSED POOL

(APPROVED DA 93/2019)

NO 12 RIVERVIEW ROAD, EARLWOOD

ARCHITECTURAL DRAWING LIST

COVER SHEET

RESIDENCE BASIX

SITE ANALYSIS PLAN

SITE ROOF PLAN

APPROVED LEVEL 0 - GARAGE

APPROVED LEVEL 1 - ENTERTAINMENT

APPROVED LEVEL 2 - GROUND FLOOR

A 106 APPROVED LEVEL 3 - FIRST FLOOR

APPROVED LEVEL 4 - SECOND FLOOR

APPROVED EASTERN ELEVATION APPROVED WESTERN ELEVATION

A 108

APPROVED NORTHERN ELEVATION APPROVED SOUTHERN ELEVATION

APPROVED SECTION 1

A 109 PROPOSED GARAGE LEVEL

PROPOSED LEVEL 1 - ENTERTAINMENT

A 110 **EASTERN ELEVATION - PROPOSED**

WESTERN ELEVATION - PROPOSED

NORTHERN ELEVATION - PROPOSED A 111

SOUTHERN ELEVATION

SECTION 1 + POOL SECTION


A 112 SECTION 2 - 5

A 113 EXTERNAL MATERIAL FINISHES

WASTE MANAGEMENT PLAN

A 114 FLOOR SPACE AREA CALCULATION

SITE COVERAGE + DEEP SOIL PLAN

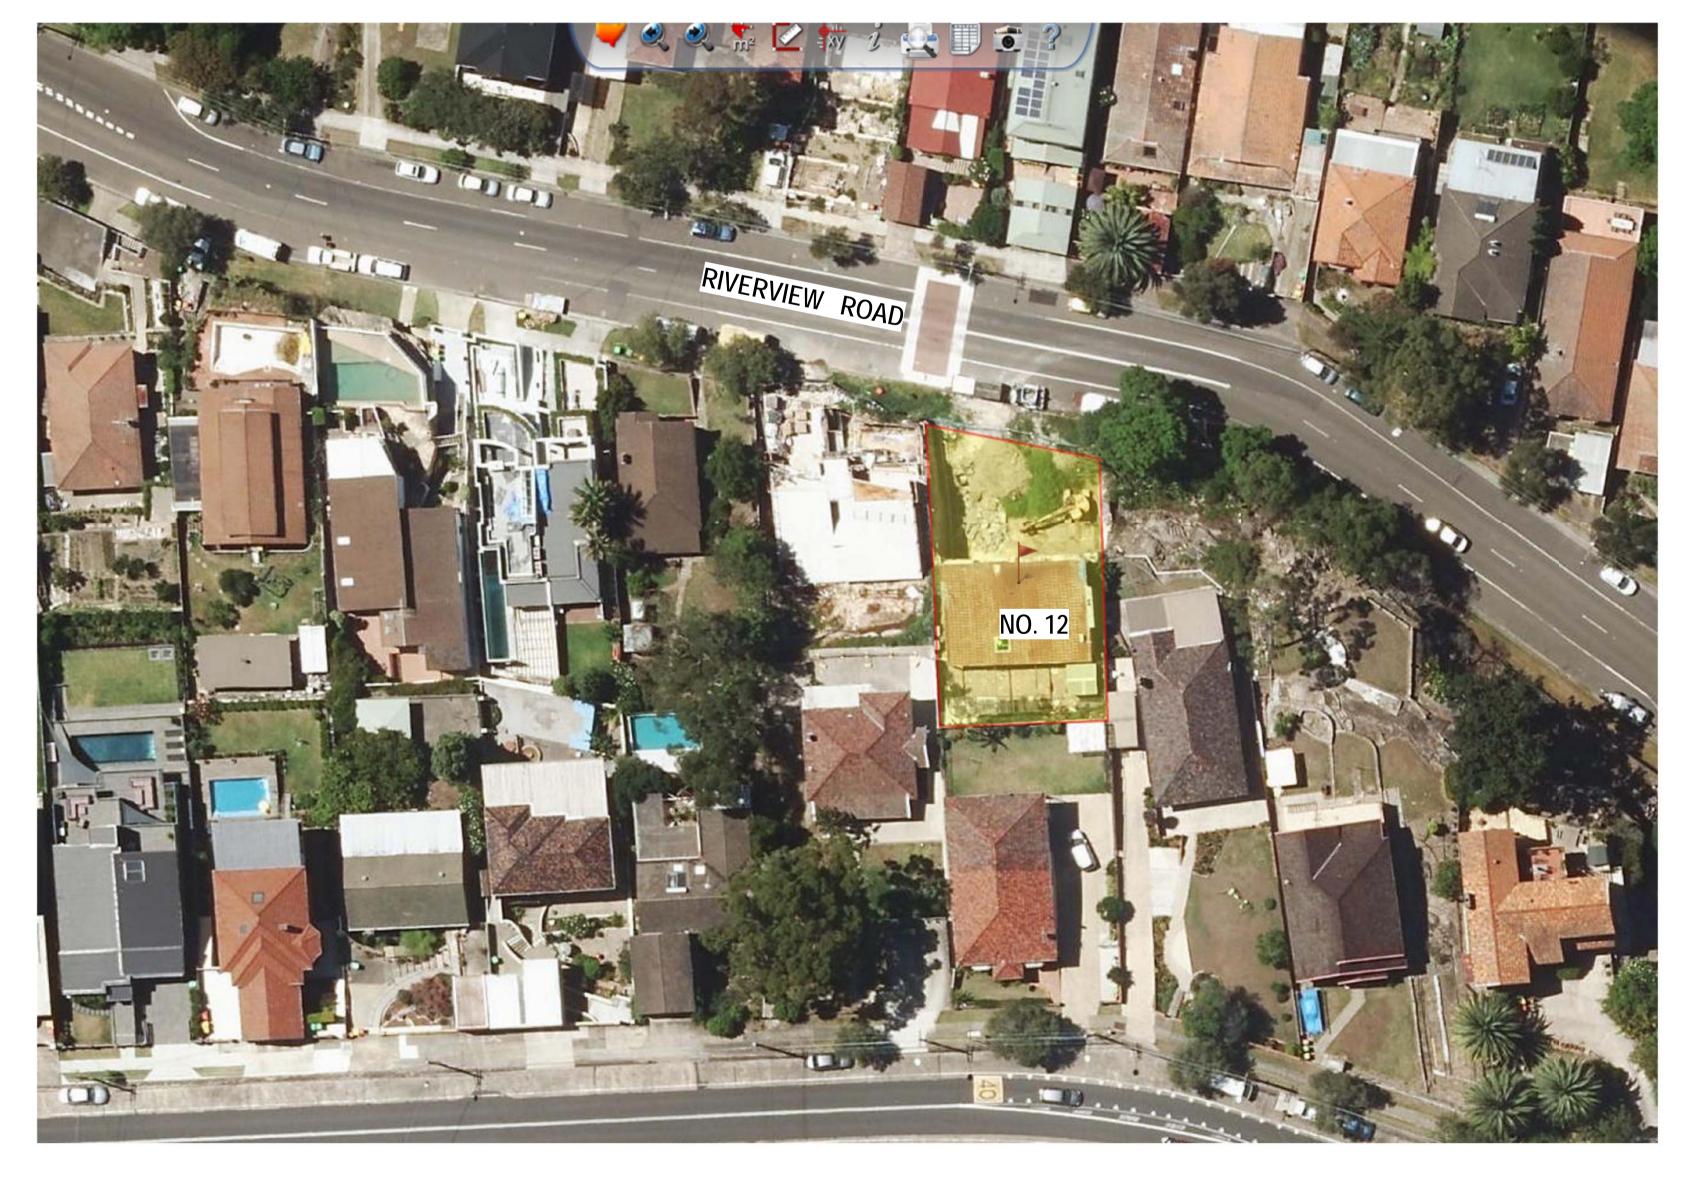

AERIAL MAP TO TRUE NORTH

GENERAL NOTES

ALL WORK TO COMPLYWITH THE BUILDING CODE OF AUSTRALIA, SAA

THESE DRAWINGS SHALL BE READ IN CONJUNCTION WITH THE DEVELOPMENT APPROVAL, CONSTRUCTION CERTIFICATE AND ANY SCHEDULES ATTACHED THERETO. ALL CONDITIONS MUST BE APPLIED TO THE DEVELOPMENT. WHERE ANY VARIATIONS ARE SOUGHT, IT IS THE

RESPONSIBILITY OF THE DEVELOPER TO CONTACT COUNCIL TO OBTAIN

APPROVAL FOR ANY SUCH VARIATIONS.

THESE DRAWINGS SHALL BE READ AS A SET AND IN CONJUNCTION WITH ALL SPECIFICATIONS, ENGINEERING PLANS AND CONSULTANTS PLANS AS SUPPLIED BY THE DEVELOPER. THESE PLANS AND SPECIFICATIONS MAY INCLUDE BUT ARE NOT LIMITED TO STRUCTURAL PLANS, STORMWATER PLANS, LANDSCAPE PLANS, HYDRAULIC PLANS ELECTRICAL DRAWINGS, MECHANICAL VENTILATION PLANS, FIRE SERVICES PLANS ETC. FINAL CO-ORDINATION OF PLANS BY BUILDER.

BUILDING MATERIALS AND COLOURS ALL EXTERNAL BUILDING MATERIALS AND COLOURS SHALL ACCORD WITH THE SCHEDULE SUBMITTED TO COUNCIL WITH THE CONSTRUCTION

- ALL DIMENSIONS TO BE CHECKED AND CONFIRMED ON SITE

- INTERNAL WALLS TIMBER FRAMED WITH GYPROCK LININGS DIMENSIONS AS SHOWN ON DRAWINGS

- EXTERNAL WALLS AS NOTED ON DRAWINGS OR SPEC

- DOOR UNITS & WINDOWS TO BE SELECTED ALUMINIUM

- ALL CRITICAL HEADROOMS TO BE CHECKED ON SITE. ALL DISCREPANCES TO BE BROUGHT TO THE ATTENTION OF THE ARCHITECT

- ALL DOCUMENTATION MUST BE FOLLOWED AS APPROVED ARCHITECT TAKES NO RESPONSIBILITY FOR MODIFICATIONS MADE

TO DESIGN NOT COVERED BY APPROVAL + CONDITIONS - ALL STORMWATER DISPOSAL TO STORMWATER DESIGN

- TIMBER FRAMING TO AS 1684 AND STRUCTURAL ENGINEER'S

- WATERPROOFING AND FLOORWASTES TO ALL WET AREAS AS REQUIRED BY BCA

-WEEPHOLES, FLASHING AND DAMP PROOF COURSE TO BCA AND **AUSTRALIAN STANDARDS**

- ALL ROOF TO WALL JUNCTIONS TO BE ADEQUATELY SEALED,

DEVELOPMENT APPLICATION

Mr Stephen J. Urch

LANDSCAPE CONSULTANT

GEOSCAPES LANDSCAPE ARCHITECTS T - 02 9411 1485

TOWN PLANNER **QUE CONSULTING** T - 1300 123 783 STRUCTURAL ENGINEERS

M - 0434 284 585

LEGEND:

A/C AIR CONDITIONER AHD AUSTRALIAN HEIGHT DATUM

NTIMA CONSULTING PTY LTD

ALUMINIUM WINDOW BALUSTRADE

DOWNPIPE

DPC DAMP PROOF COURSE

EXISTING

FINISHED CEILING LEVEL FFL FINISHED FLOOR LEVEL

RELATIVE LEVEL

RWH RAIN WATER HEAD SKL SKYLIGHT

TBC TO BE CONFIRMED

TME TO MATCH EXISTING

TW TIMBER WINDOW VOS VERIFY ON SITE

ALUMINIUM **BRICK**

GAL GALVANISED

GLASS DOOR MRS METAL ROOF SHEETING

P PAINT

PBD PLASTERBOARD REINFORCED CONCRETE

STONE SANDSTONE

TIMBER

TIMBER BATTENS TIMBER DOOR

TL TILE TL/SL TILE SLATE ROOF

W WINDOW WB WEATHERBOARD

WC WATER CLOSET (TOILET)

DEVELOPMENT APPLICATION:

PROPOSED POOL & PLANT ROOM ADDED

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Do not scale drawings. Verify all dimensions on site. Notify architect of all discrepancies

AMMENDMENT Proiect:

12 Riverview Road NSW **Earlwood**

LOT B. DP 420152

Title Sheet

Project number **5743**

15-09-22

Scale: 1:100 @ A1

Drawn by: KP

Checked by: JD

A100

Cad Draft P/L

SUITE 1, 505 BALMAIN ROAD.

LILYFIELD, NSW
P.O BOX 446 GLADESVILLE 2111

MOBILE: 0410 699919 info@caddraftnsw.com.au

BASIX:

WATER COMMITMENTS:

LANDSCAPE:

The applicant must plant indigenous or low water use species of vegetation throughout 166 square metres of the site.

FIXTURES:

The applicant must install showerheads with a minimum rating of 4 star (> 4.5 but <= 6 L/min plus spray force and/or coverage tests) in all showers in the development.

The applicant must install a toilet flushing system with a minimum rating of 5 star in each toilet in the development.

The applicant must install taps with a minimum rating of 5 star in the kitchen in the development.

The applicant must install basin taps with a minimum rating of 5 star in each bathroom in the development.

ALTERNATIVE WATER:

RAINWATER TANK:

The applicant must install a rainwater tank of at least 10000 litres on the site. This rainwater tank must meet, and be installed in accordance with, the requirements of all applicable regulatory authorities.

The applicant must configure the rainwater tank to collect rain runoff from at least 200 square metres of the roof area of the development (excluding the area of the roof which drains to any stormwater tank or private dam).

The applicant must configure the rainwater tank so that overflow is diverted to a stormwater tank.

The applicant must connect the rainwater tank to:

- all toilets in the development
- at least one outdoor tap in the development (Note: NSW Health does not recommend that rainwater be used for human consumption in areas with potable water supply.)
- a tap that is located within 10 metres of the swimming pool in the development

STORMWATER TANK:

The applicant must install a stormwater tank with a capacity of at least 5000 litres on the site. This stormwater tank must meet, and be installed in accordance with, the requirements of all applicable regulatory authorities.

The applicant must configure the stormwater tank to collect overflow from the rainwater tank.

- The applicant must configure the stormwater tank to collect runoff from:
- at least 200 square metres of roof area of the development (excluding the area of the roof which drains to any rainwater tank or private dam)
- at least 100 square metres of impervious areas
- at least 100 square metres of mipervious areas
 at least 100 square metres of garden and lawn
- The applicant must connect the stormwater tank to:

• a sub-surface or non-aerosol irrigation system, or if the stormwater has been appropriately treated in accordance with applicable regulatory requirements, to at least one outdoor tap in the development (Note: NSWHealth does not recommend that stormwater be used to irrigate edible plants which are consumed raw.)

SWIMMING POOL:

The swimming pool must not have a volume greater than 21 kilolitres.

The swimming pool must have a pool cover.

The swimming pool must be shaded.

The swimming pool must be outdoors.

THERMAL COMFORT COMMITMENTS:

GENERAL FEATURES:

The dwelling must be a Class 1 dwelling according to the Building Code of Australia, and must not have more than 2 storeys.

The conditioned floor area of the dwelling must not exceed 300 square metres.

The dwelling must not contain open mezzanine area exceeding 25 square metres.

The dwelling must not contain third level habitable attic room.

FLOOR, WALLS AND CEILING / ROOF:

The applicant must construct the floor(s), walls, and ceiling/roof of the dwelling in accordance with the specifications listed in the table below.

Construction	Additional insulation required (R-Value)	Other specifications
floor - suspended floor above garage, concrete	nil	
external wall - brick veneer	2.86 (or 3.40 including construction)	
ceiling and roof - flat ceiling / flat roof, framed	ceiling: 4.5 (up), roof: foil/sarking	framed; light (solar absorptance < 0.475)

WINDOWS, GLAZED DOORS AND SKYLIGHTS:

The applicant must install the windows, glazed doors and shading devices described in the table below, in accordance with the specifications listed in the table. Relevant overshadowing specifications must be satisfied for each window and glazed door.

The dwelling may have 1 skylight (<0.7 square metres) which is not listed in the table.

The following requirements must also be satisfied in relation to each window and glazed door:

- For the following glass and frame types, the certifier check can be performed by visual inspection.
 - Aluminium single clear
 - Aluminium double (air) clear
 - Timber/uPVC/fibreglass single clear
 - Timber/uPVC/fibreglass double (air) clear
- For other glass or frame types, each window and glazed door must be accompanied with certification showing a U value no greater than that listed and a Solar Heat Gain Coefficient (SHGC) within the range of those listed. Total system U values and SHGC must be calculated in accordance with National Fenestration Rating Council (NFRC) conditions. Frame and glass types shown in the table below are for reference only.
- Overshadowing buildings/vegetation must be of the height and distance from the centre and the base of the window and glazed door, as specified in the 'overshadowing' column.

The applicant must install the skylights described in the table below, in accordance with the specifications listed in the table. Total skylight area must not exceed 3 square metres (the 3 square metre limit does not include the optional additional skylight of less than 0.7 square metres that does not have to be listed in the table).

Skylight no.	Maximum area (m²)	Туре		Shading
S01	0.20	aluminium, moulde	ed plastic single clear	no shading
S02	0.20	aluminium, moulde	ed plastic single clear	no shading

Window/glazed door no	Max height (mm)	Max width(mm)	Type	Shading (Dim within 10%)	Overshadowing_
Bedroom 1 & 2	2100	4200	U-value: 3.6, SHGC: 0.486 - 0.594 (aluminium: thermally broken, double (air), clear)	solid overhang 1500 mm, 2300 mm above head of window or glazed door	1-2 m high <1.5 m away
Level 4 East	500	3000	U-value: 3.6, SHGC: 0.486 - 0.594 (aluminium: thermally broken, double (air), clear)	solid overhang 2000 mm, 2300 mm above head of window or glazed door	1-2 m high <1.5 m away
Master Bedroom	2100	4200	U-value: 3.6, SHGC: 0.486 - 0.594 (aluminium: thermally broken, double (air), clear)	solid overhang 2000 mm, 2300 mm above head of window or glazed door	1-2 m high <1.5 m away
Living	2100	4800	U-value: 3.6, SHGC: 0.486 - 0.594 (aluminium: thermally broken, double (air), clear)	solid overhang 2000 mm, 2300 mm above head of window or glazed door	1-2 m high <1.5 m away
Family	2100	4200	U-value: 3.6, SHGC: 0.486 - 0.594 (aluminium: thermally broken, double (air), clear)	solid overhang 2000 mm, 2300 mm above head of window or glazed door	1-2 m high <1.5 m away
Dining	2100	4800	U-value: 3.6, SHGC: 0.486 - 0.594 (aluminium: thermally broken, double (air), clear)	solid overhang 2000 mm, 2300 mm above head of window or glazed door	1-2 m high <1.5 m away

ENERGY COMMITMENTS:

HOT WATER:

The applicant must install the following hot water system in the development, or a system with a higher energy rating: gas instantaneous with a performance of 5.5 stars.

NATURAL LIGHTING:

The applicant must install a window and/or skylight in the kitchen of the dwelling for natural lighting.

The applicant must install a window and/or skylight in 5 bathroom(s)/toilet(s) in the development for natural lighting.

DEVELOPMENT APPLICATION

CLIENT

Mr Stephen J. Urch

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TOWN PLANNER
QUE CONSULTING
T-1300 123 783

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LEGEND:

A/C AIR CONDITIONER
AHD AUSTRALIAN HEIGHT DATUM
AW ALUMINIUM WINDOW
BAL BALUSTRADE
DP DOWNPIPE

DP DOWNPIPE
DPC DAMP PROOF COURSE
(E) EXISTING

STRUCTURAL ENGINEERS

EQ EQUAL
FCL FINISHED CEILING LEVEL
FFL FINISHED FLOOR LEVEL

(N) NEW
RL RELATIVE LEVEL
RWH RAIN WATER HEAD
SKL SKYLIGHT

SKL SKYLIGHT
TBC TO BE CONFIRMED
TME TO MATCH EXISTING
TW TIMBER WINDOW

VOS VERIFY ON SITE
AL ALUMINIUM
BK BRICK

GAL GALVANISED GD GLASS DOOR MRS METAL ROOF SHEETING

P PAINT
PBD PLASTERBOARD
RC REINFORCED CONCRETE

ST STONE
SST SANDSTONE
T TIMBER
TB TIMBER BATTENS

TD TIMBER DOOR
TL TILE
TL/SL TILE SLATE ROOF
W WINDOW

WB WEATHERBOARD

WC WATER CLOSET (TOILET)

DEVELOPMENT APPLICATION: PROPOSED POOL & PLANT ADDED

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Do not scale drawings. Verify all dimensions on site. Notify architect of all discrepancies

Project:

12 Riverview Road

Earlwood NSW LOT B. DP 420152

Residence Basix

Project number **5743**

Date: 15-09-22 Scale: 1:100 @ A1

Drawn by: KP

Checked by: JD

Cad Draft P/L


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MOBILE: 0410 699919 info@caddraftnsw.com.au

DATE





CLIENT
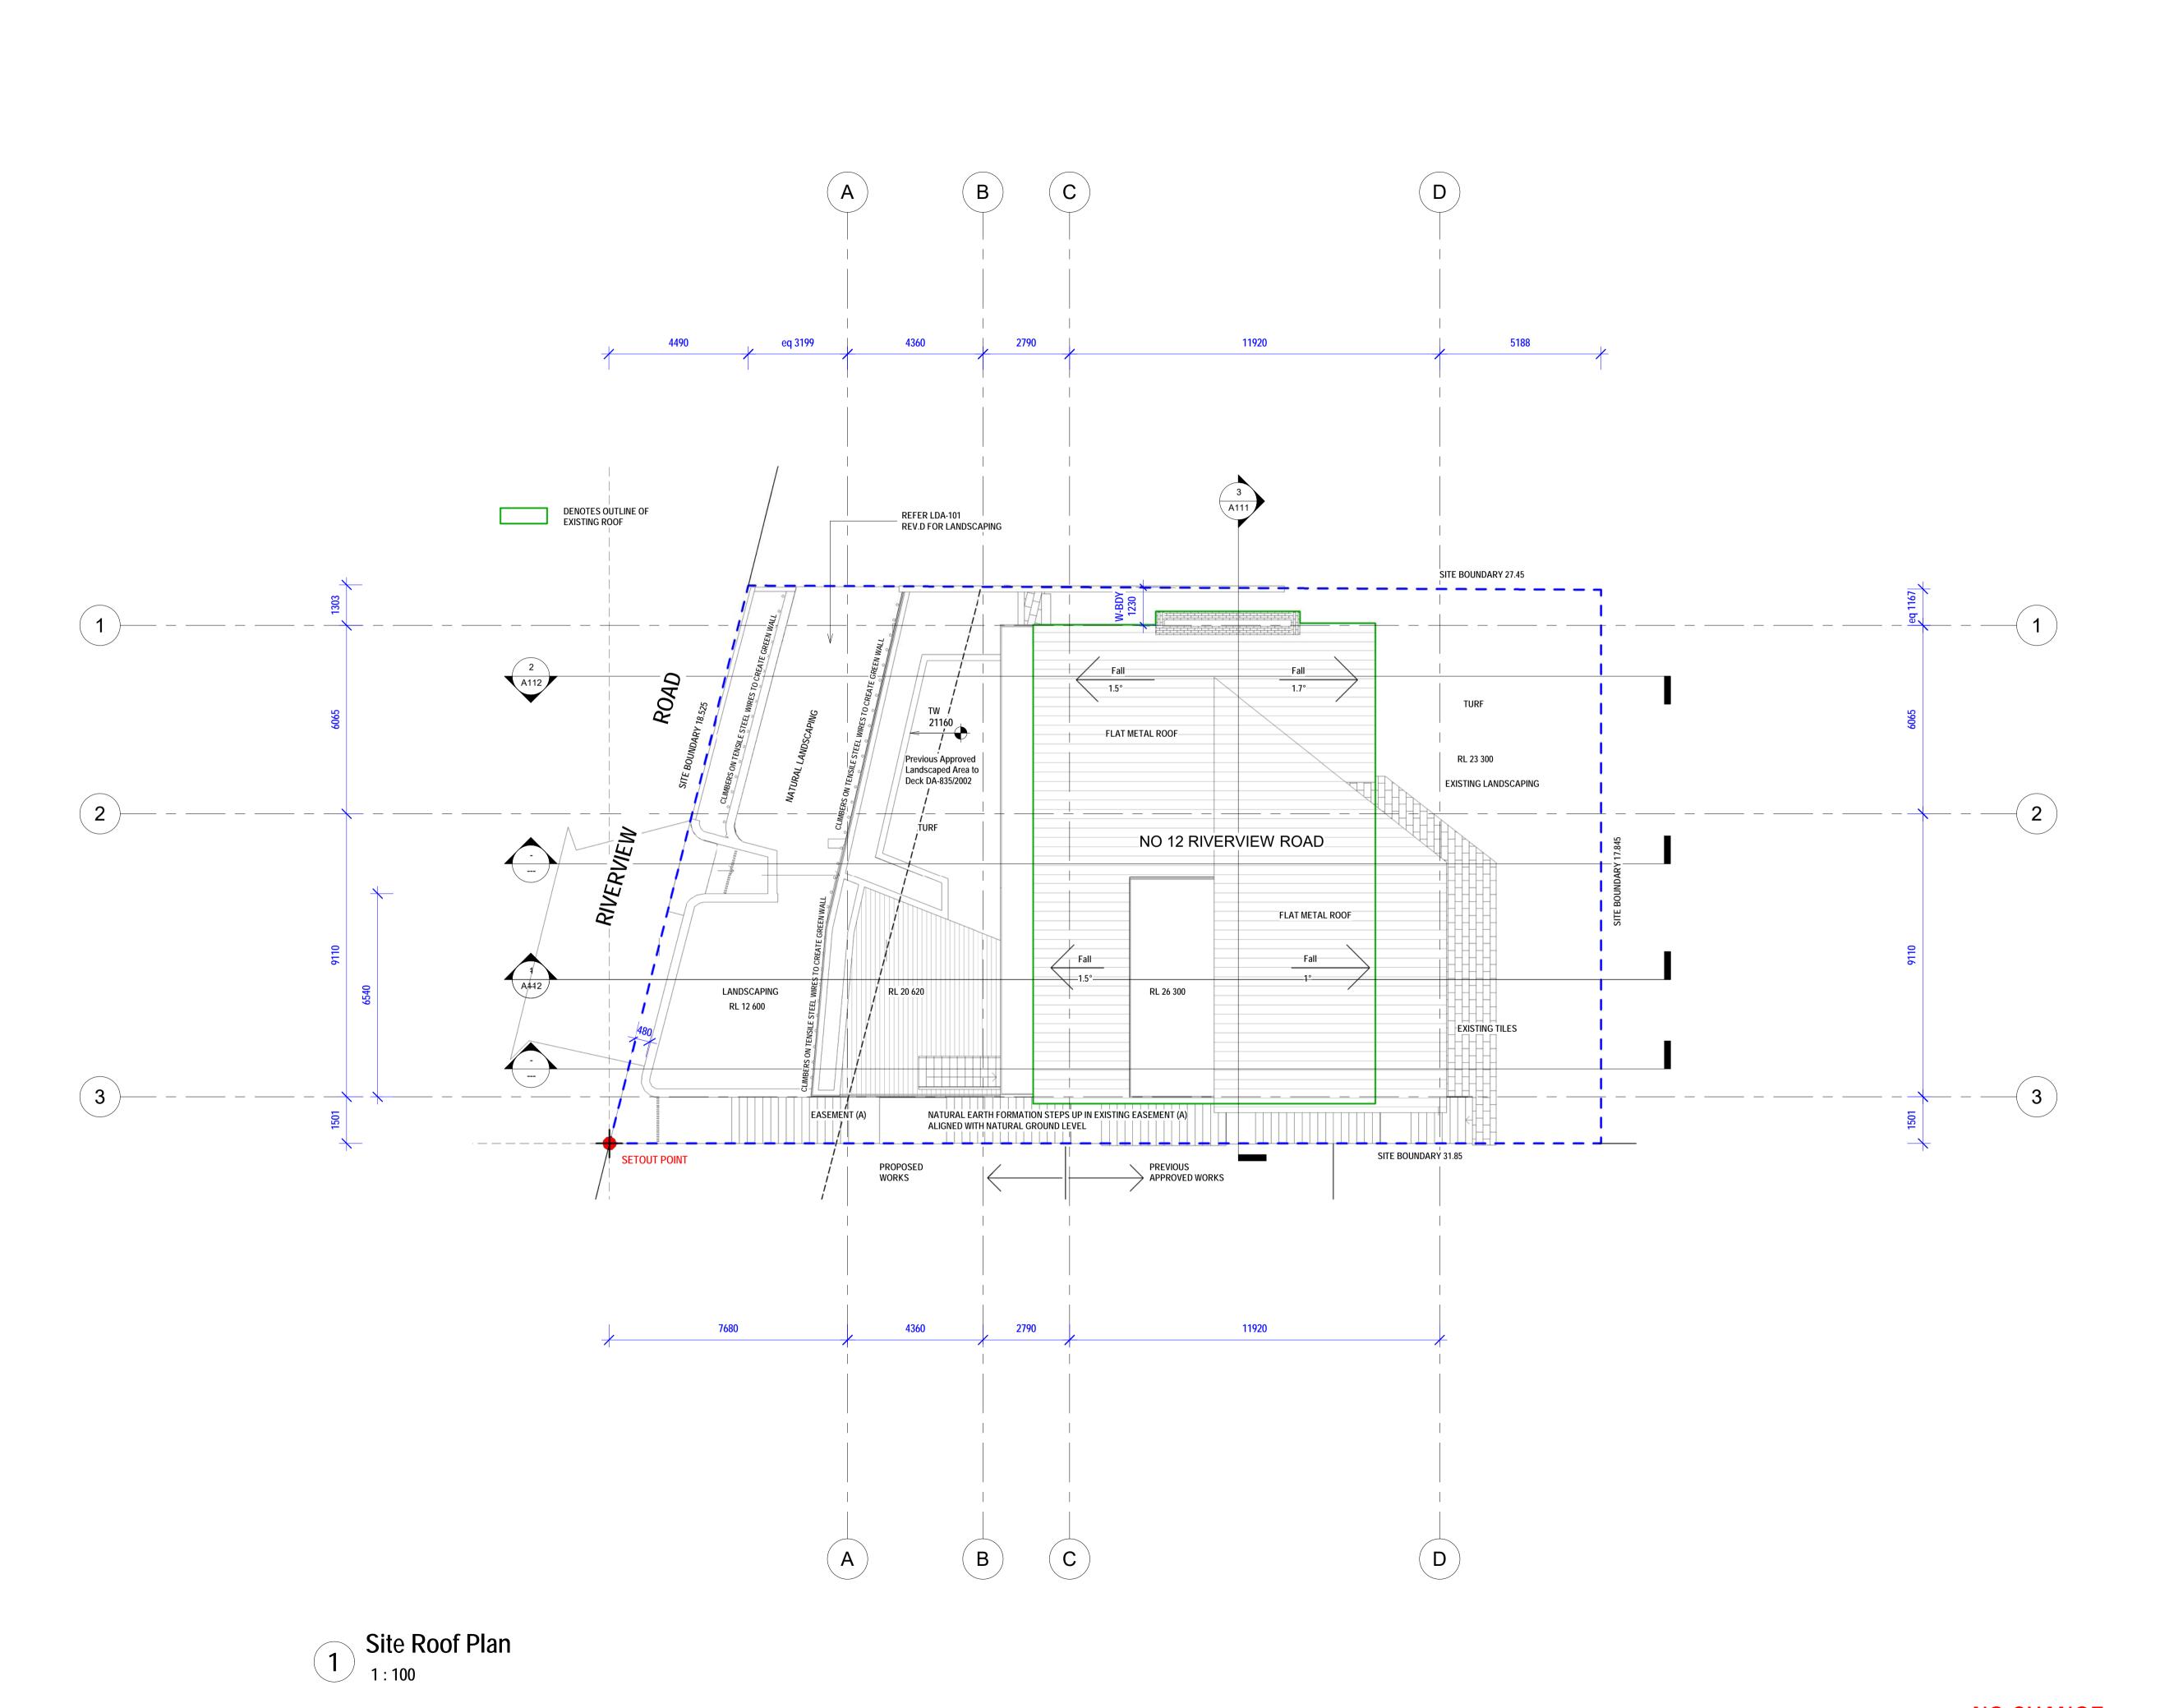
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STRUCTURAL ENGINEERS NTIMA CONSULTING PTY LTD M - 0434 284 585

LEGEND:

A/C AIR CONDITIONER AHD AUSTRALIAN HEIGHT DATUM AW ALUMINIUM WINDOW

BAL BALUSTRADE

DP DOWNPIPE DPC DAMP PROOF COURSE

(E) EXISTING EQ EQUAL FCL FINISHED CEILING LEVEL FFL FINISHED FLOOR LEVEL

(N) NEW RL RELATIVE LEVEL RWH RAIN WATER HEAD

SKL SKYLIGHT TBC TO BE CONFIRMED TME TO MATCH EXISTING

TW TIMBER WINDOW VOS VERIFY ON SITE AL ALUMINIUM

BK BRICK GAL GALVANISED

GD GLASS DOOR MRS METAL ROOF SHEETING P PAINT PBD PLASTERBOARD

RC REINFORCED CONCRETE ST STONE SST SANDSTONE

T TIMBER TB TIMBER BATTENS TD TIMBER DOOR TL TILE

TL/SL TILE SLATE ROOF W WINDOW WB WEATHERBOARD

WC WATER CLOSET (TOILET)

DEVELOPMENT APPLICATION: PROPOSED POOL & PLANT ROOM ADDED

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AMMENDMENT ISSUE DATE Project:

NSW **Earlwood LOT B. DP 420152**

12 Riverview Road

Site Roof Plan

15-09-22 1:100 1:100 @ A1 Scale:


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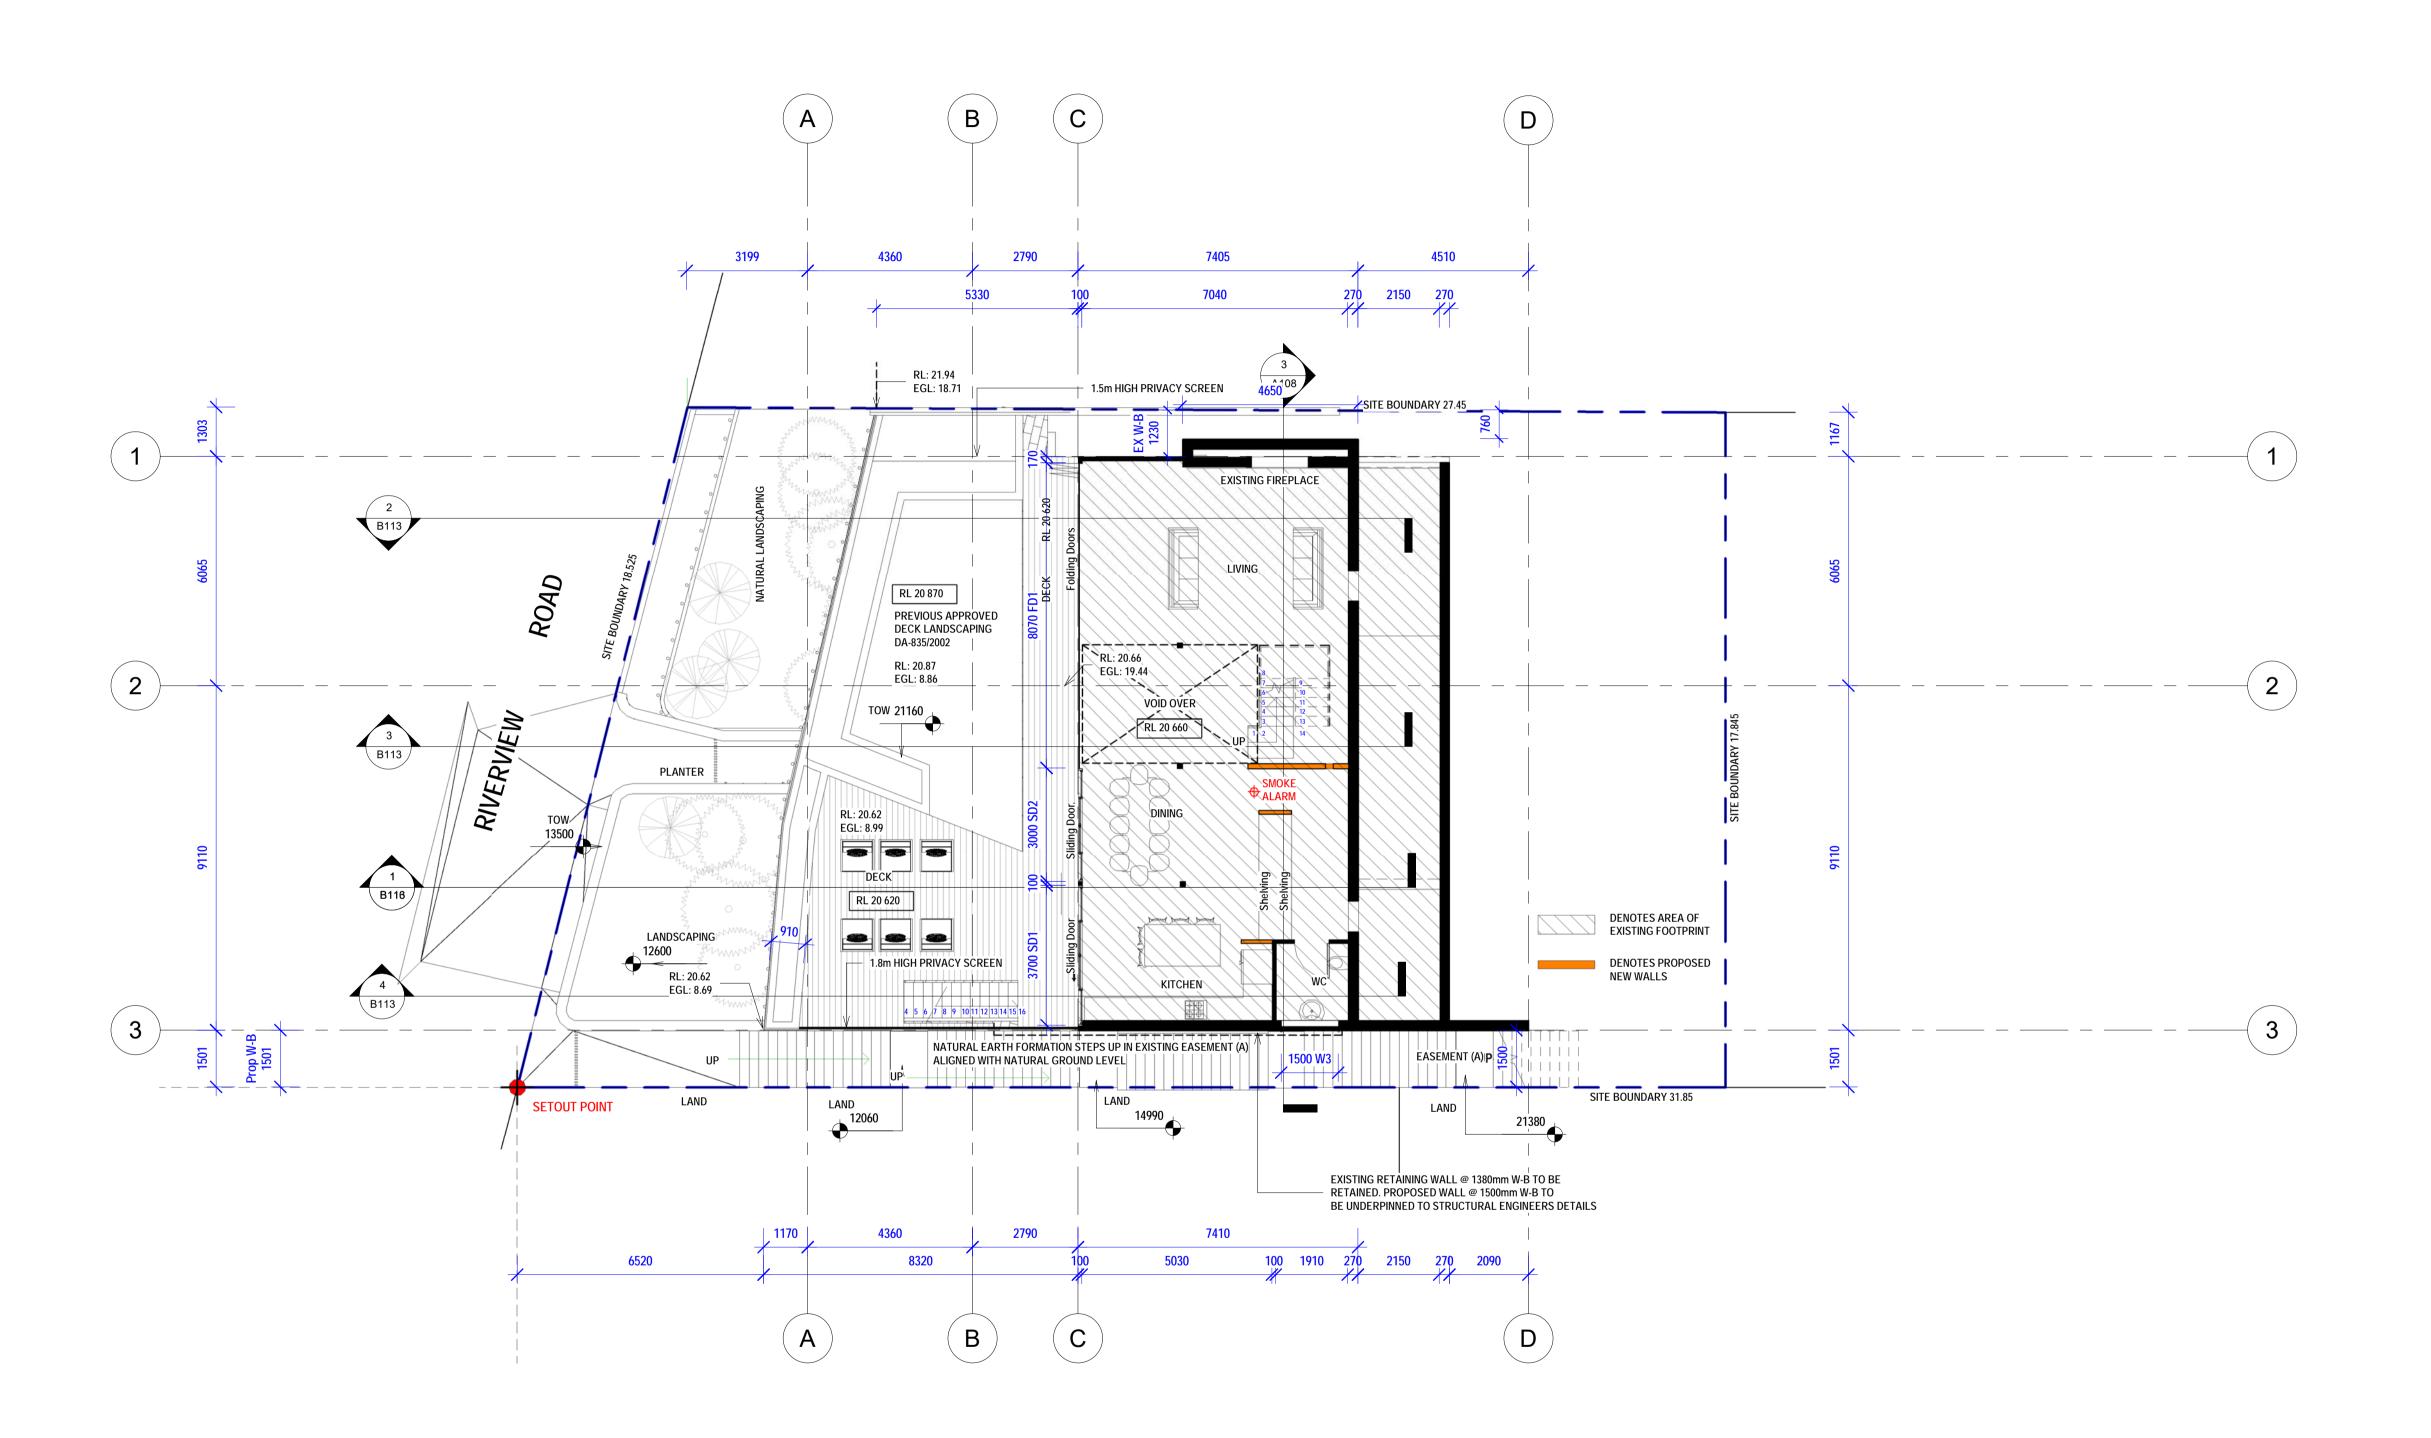
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Approved Level 2 Ground Floor
1:100

DEVELOPMENT APPLICATION

CLIENT

Mr Stephen J. Urch

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STRUCTURAL ENGINEERS NTIMA CONSULTING PTY LTD M - 0434 284 585

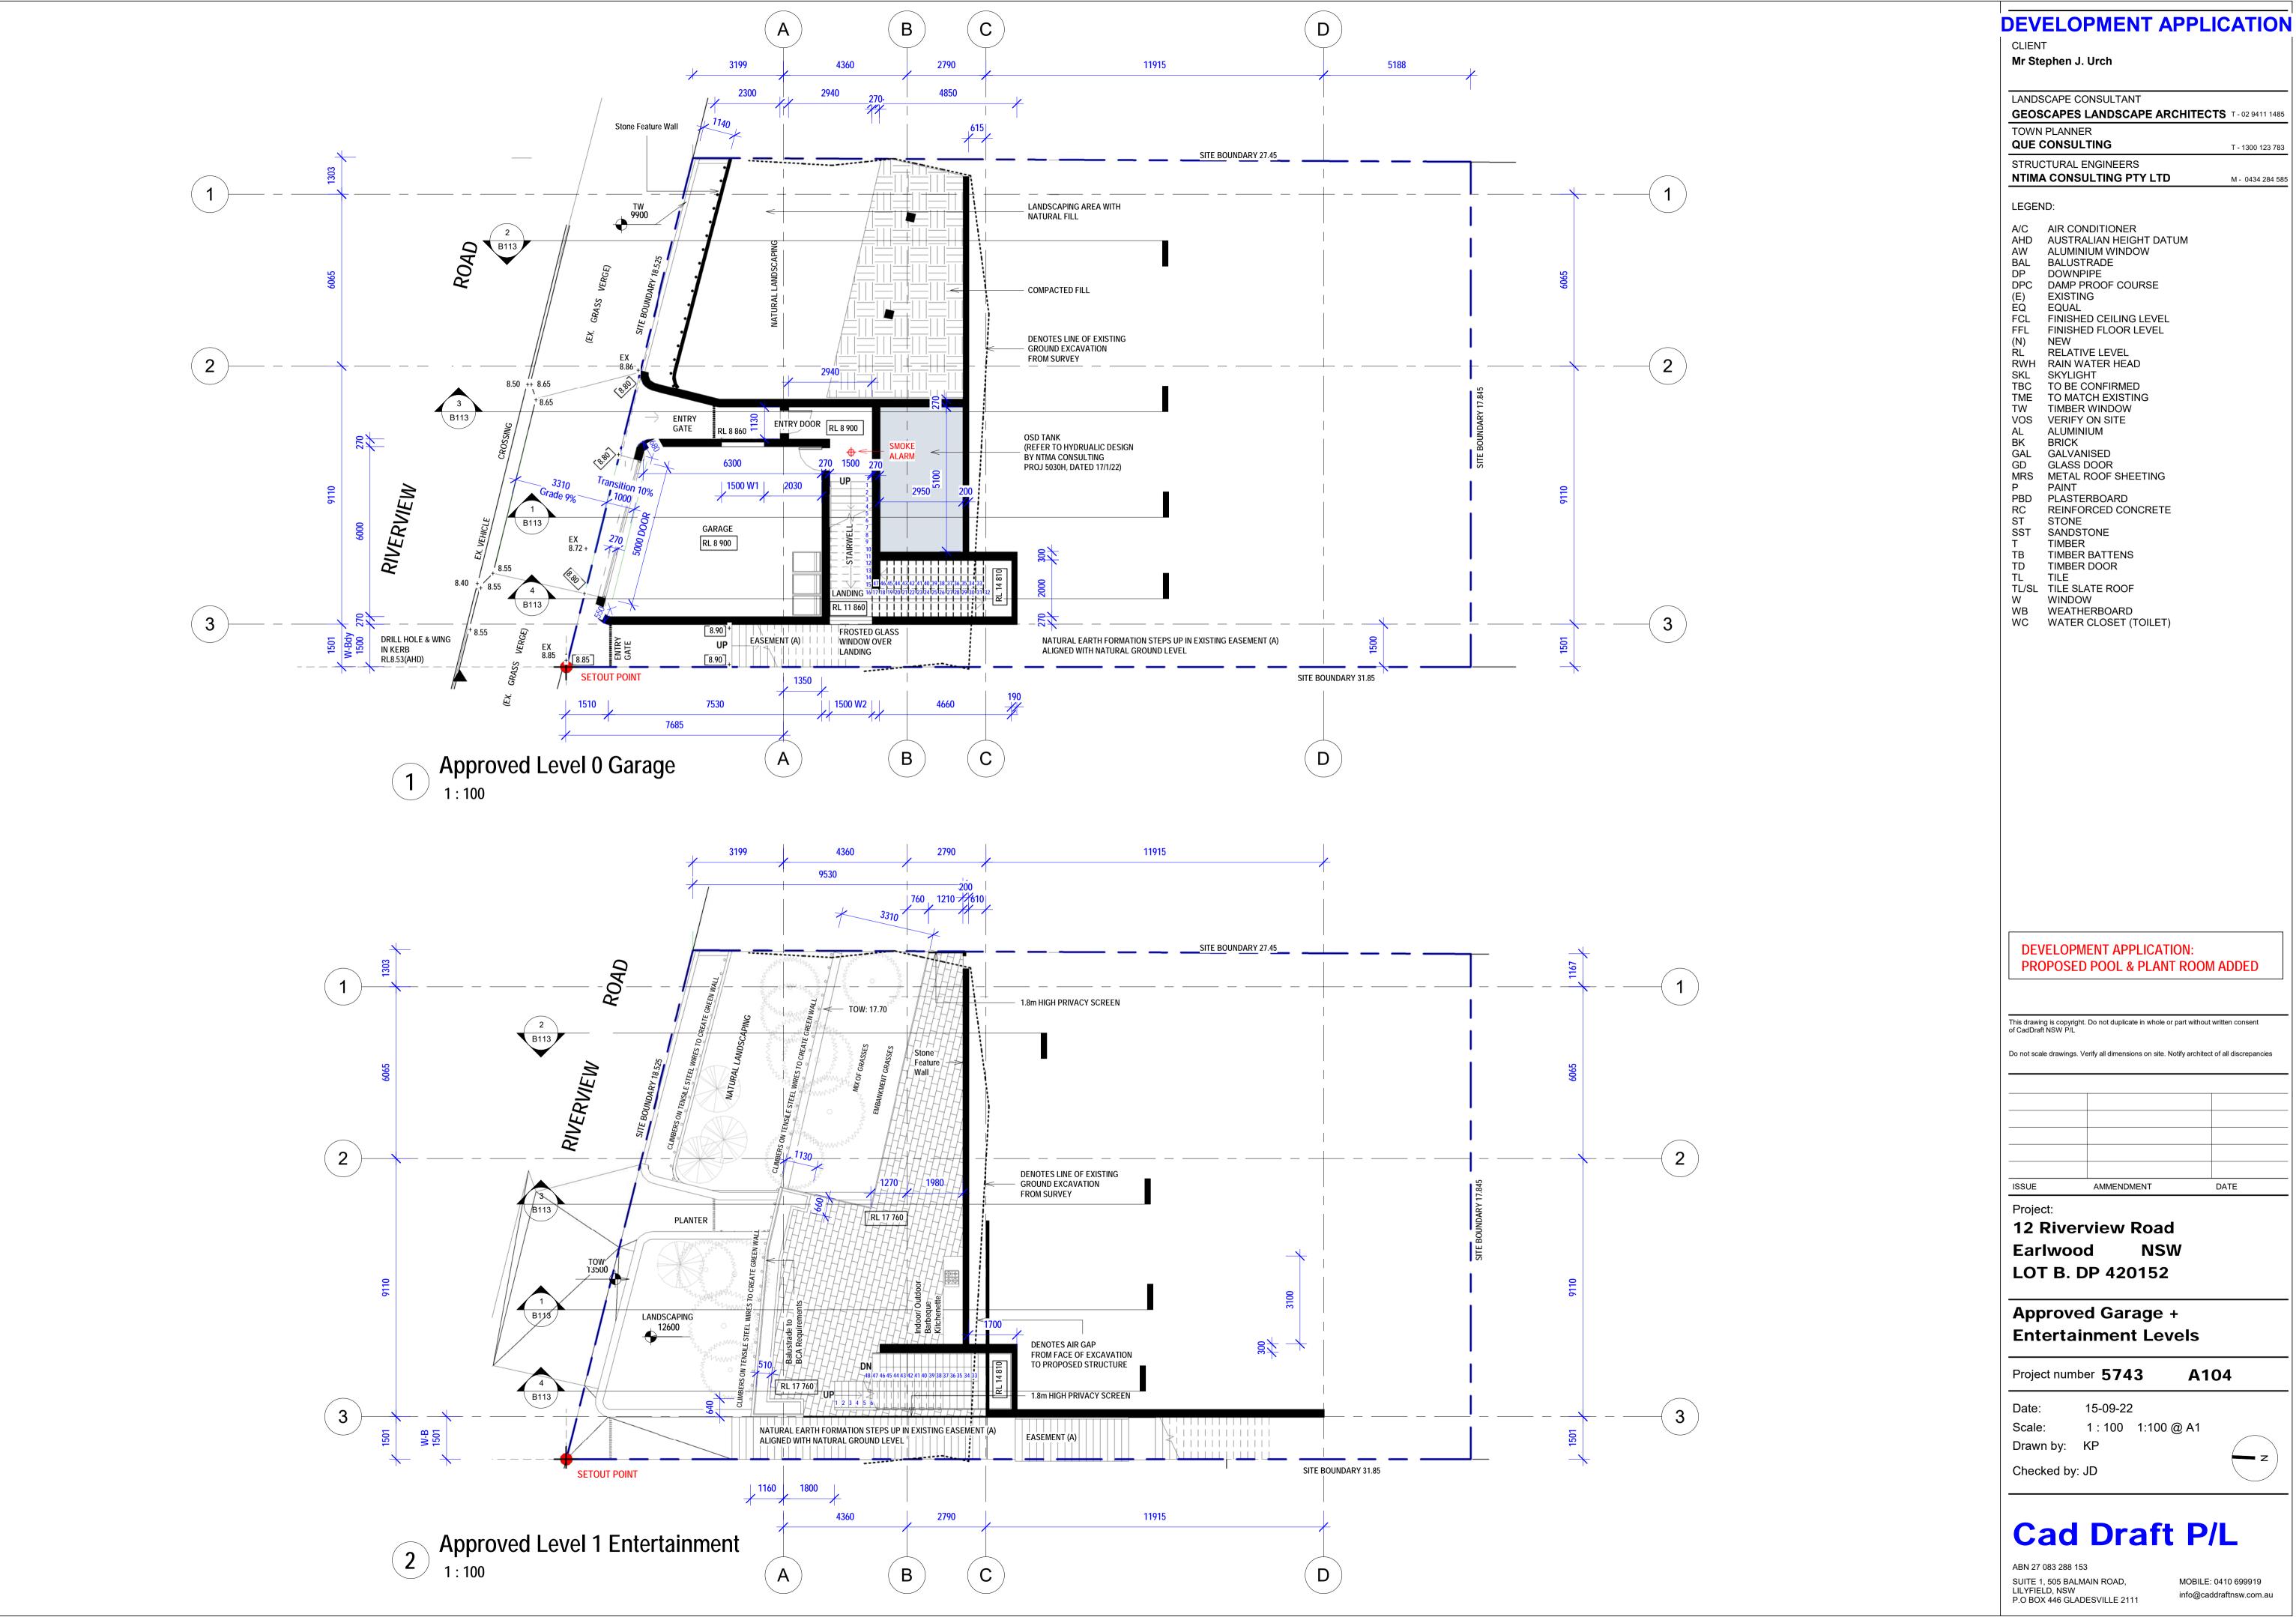LEGEND:

A/C AIR CONDITIONER AHD AUSTRALIAN HEIGHT DATUM

AW ALUMINIUM WINDOW BAL BALUSTRADE

DP DOWNPIPE

DPC DAMP PROOF COURSE

(E) EXISTING EQ EQUAL FCL FINISHED CEILING LEVEL

FFL FINISHED FLOOR LEVEL (N) NEW RL RELATIVE LEVEL

RWH RAIN WATER HEAD

SKL SKYLIGHT TBC TO BE CONFIRMED

TME TO MATCH EXISTING

TW TIMBER WINDOW VOS VERIFY ON SITE AL ALUMINIUM

BK BRICK GAL GALVANISED

GD GLASS DOOR MRS METAL ROOF SHEETING P PAINT

PBD PLASTERBOARD
RC REINFORCED CONCRETE
ST STONE

SST SANDSTONE T TIMBER

TB TIMBER BATTENS TD TIMBER DOOR TL TILE

TL/SL TILE SLATE ROOF W WINDOW WB WEATHERBOARD

WC WATER CLOSET (TOILET)

DEVELOPMENT APPLICATION: PROPOSED POOL & PLANT ROOM ADDED

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AMMENDMENT DATE Project:

NSW **Earlwood** LOT B. DP 420152

12 Riverview Road

Approved Level 2 - Ground Floor

Project number **5743**

15-09-22

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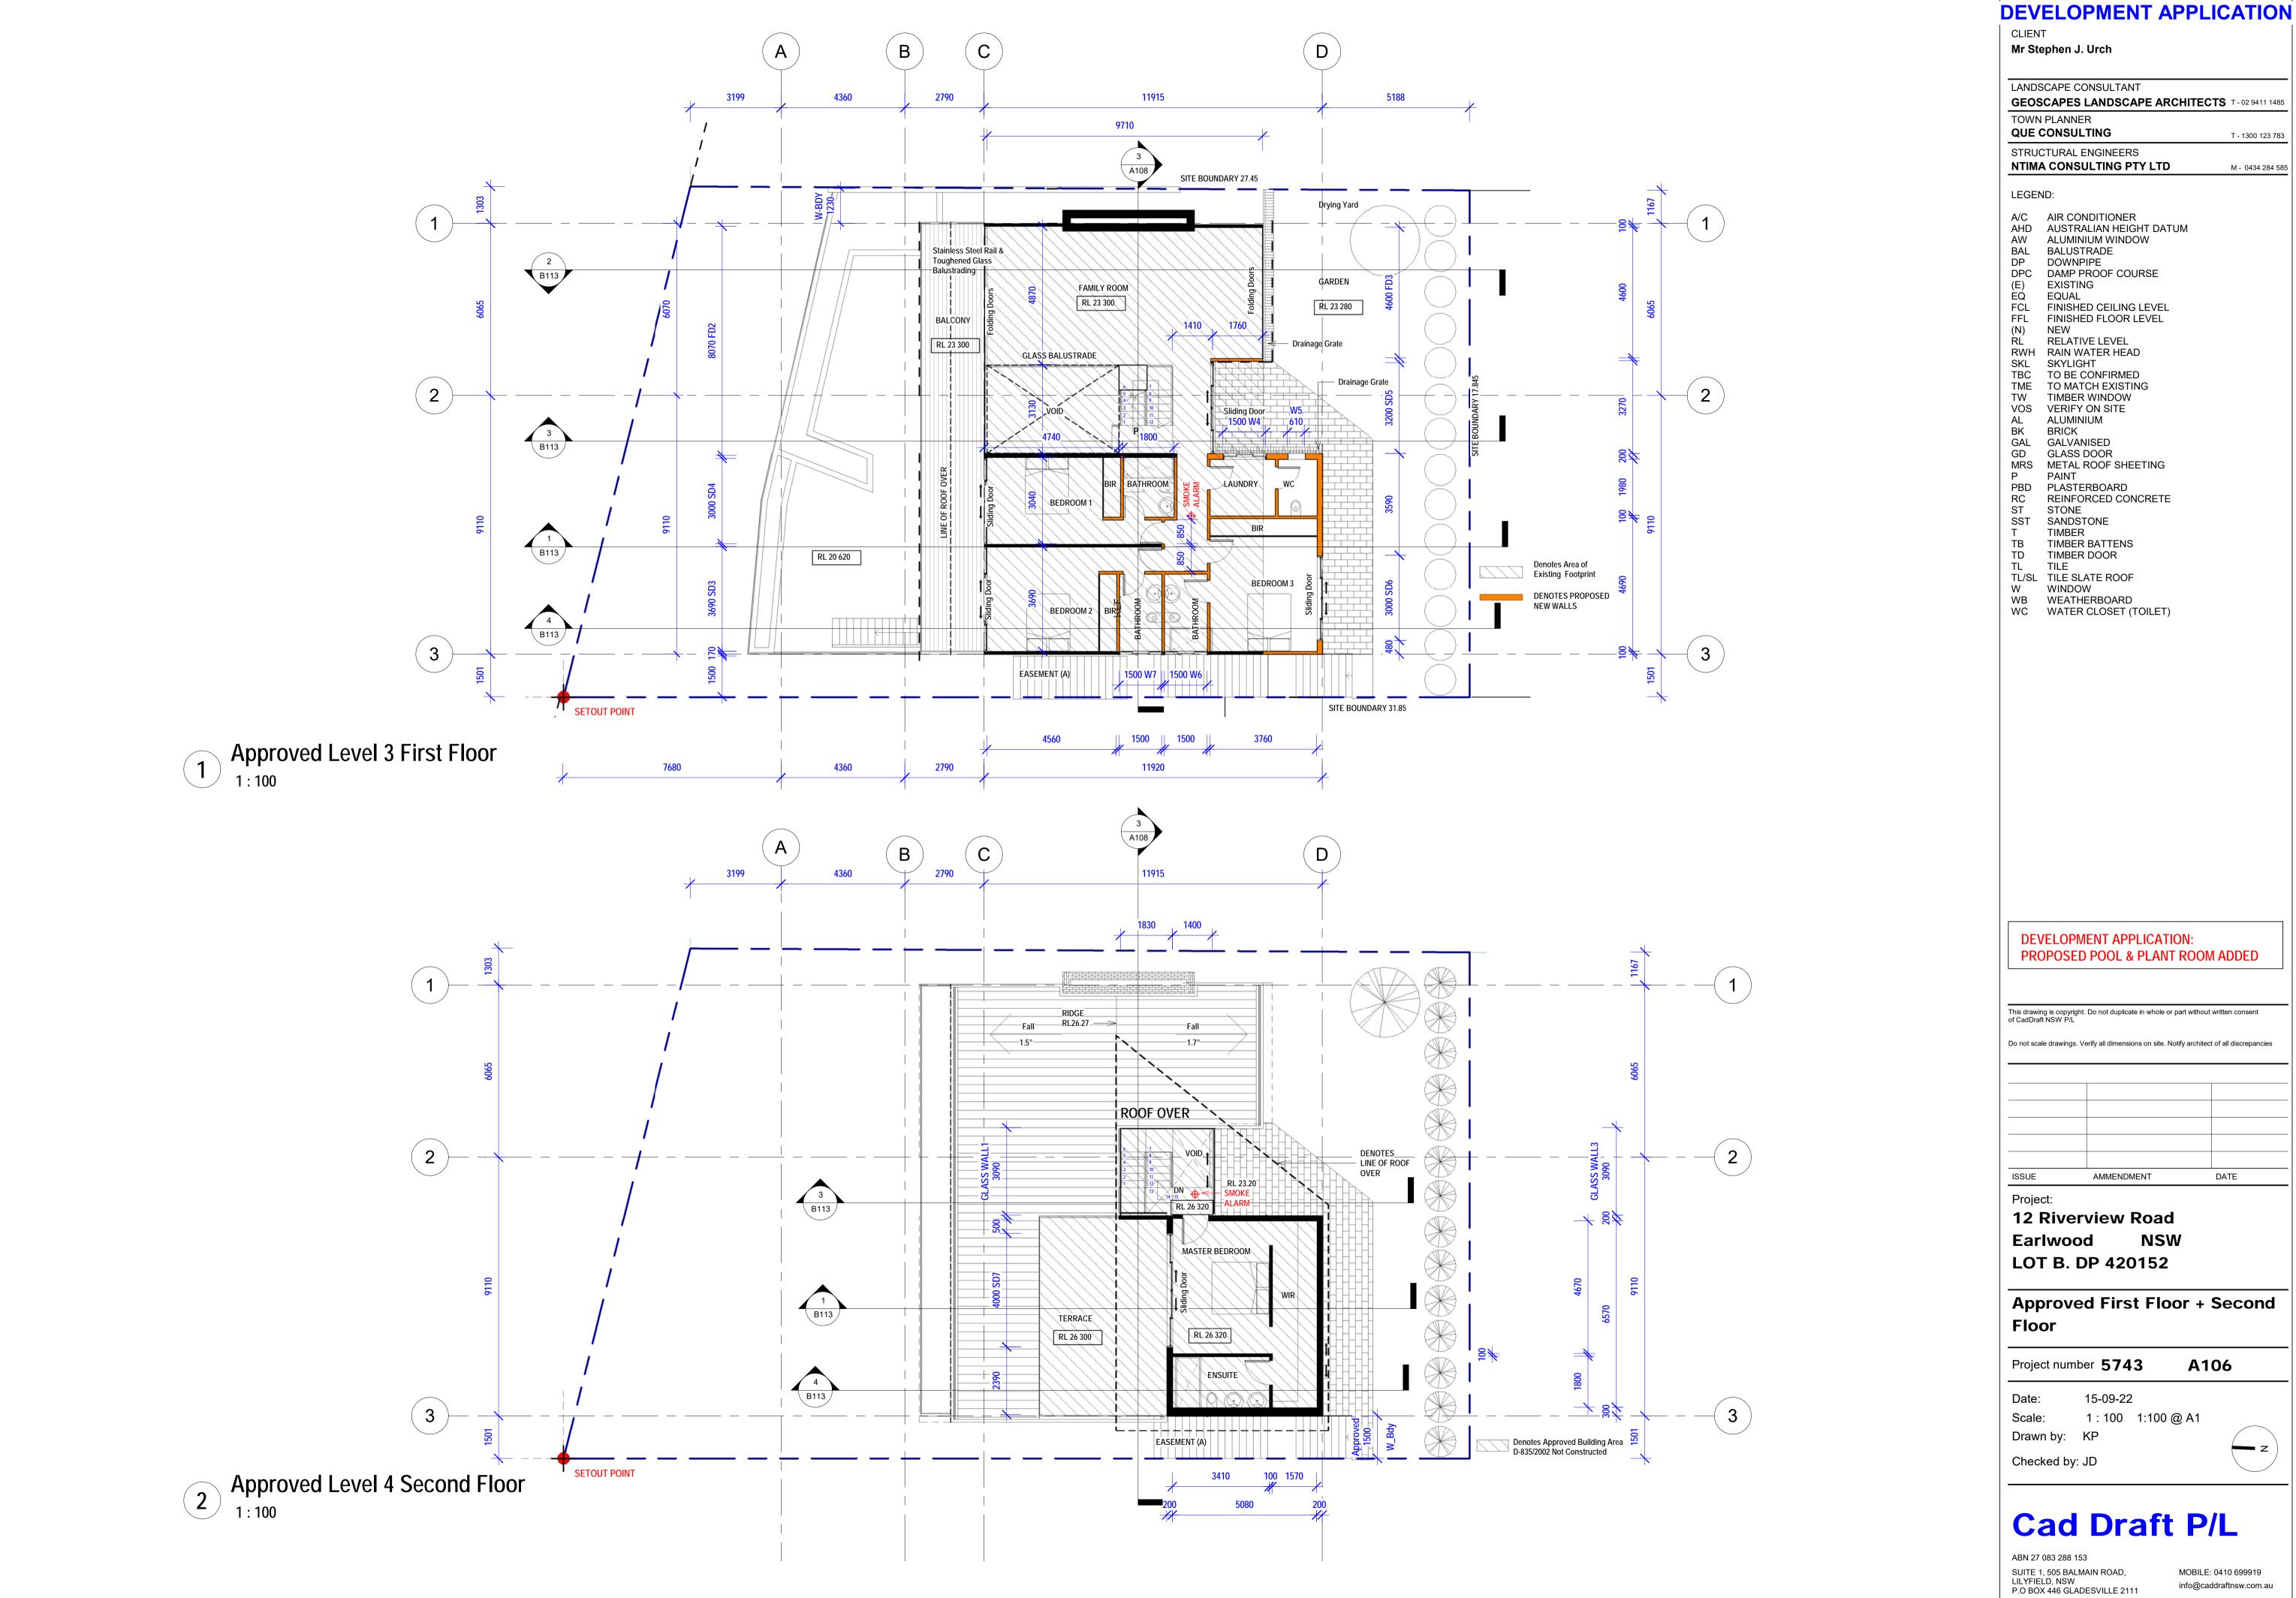
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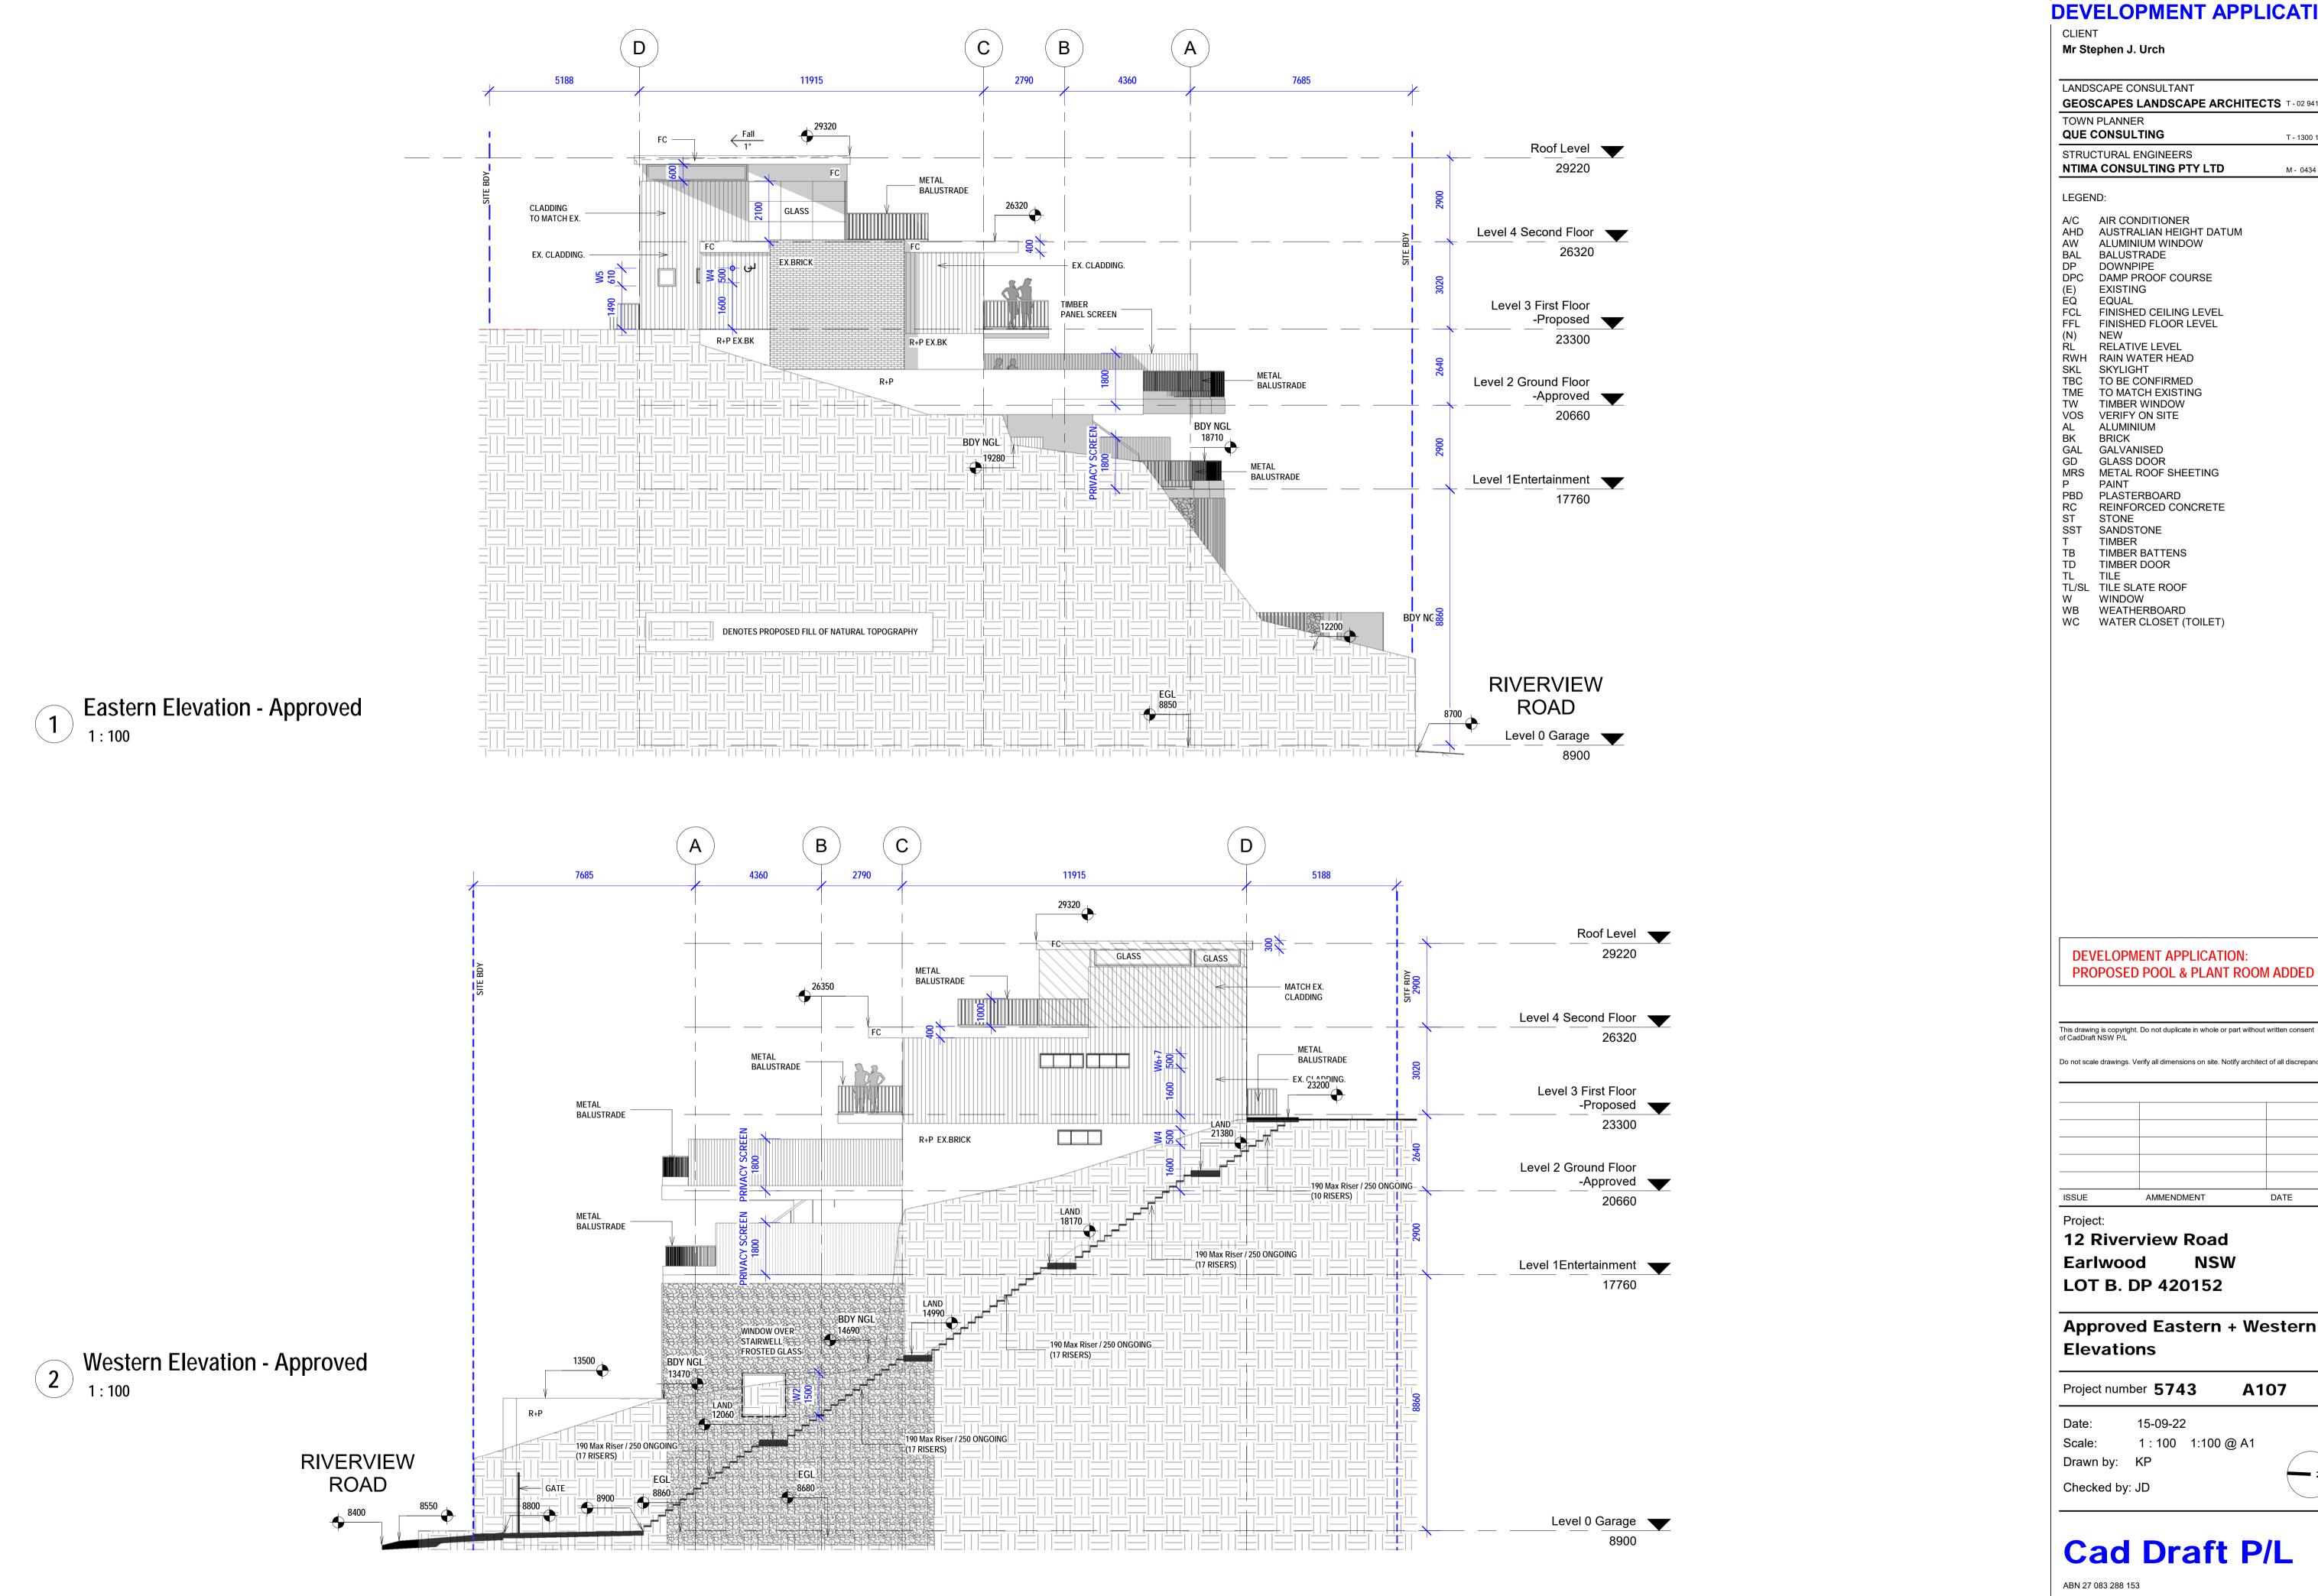


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T - 1300 123 783

NTIMA CONSULTING PTY LTD M - 0434 284 585

AHD AUSTRALIAN HEIGHT DATUM

DPC DAMP PROOF COURSE

FCL FINISHED CEILING LEVEL

FFL FINISHED FLOOR LEVEL

(N) NEW RL RELATIVE LEVEL

TBC TO BE CONFIRMED TME TO MATCH EXISTING

TW TIMBER WINDOW

MRS METAL ROOF SHEETING

RC REINFORCED CONCRETE

TB TIMBER BATTENS

TL/SL TILE SLATE ROOF

WB WEATHERBOARD

WC WATER CLOSET (TOILET)

DEVELOPMENT APPLICATION:

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DATE

AMMENDMENT

NSW

Approved Eastern + Western

15-09-22


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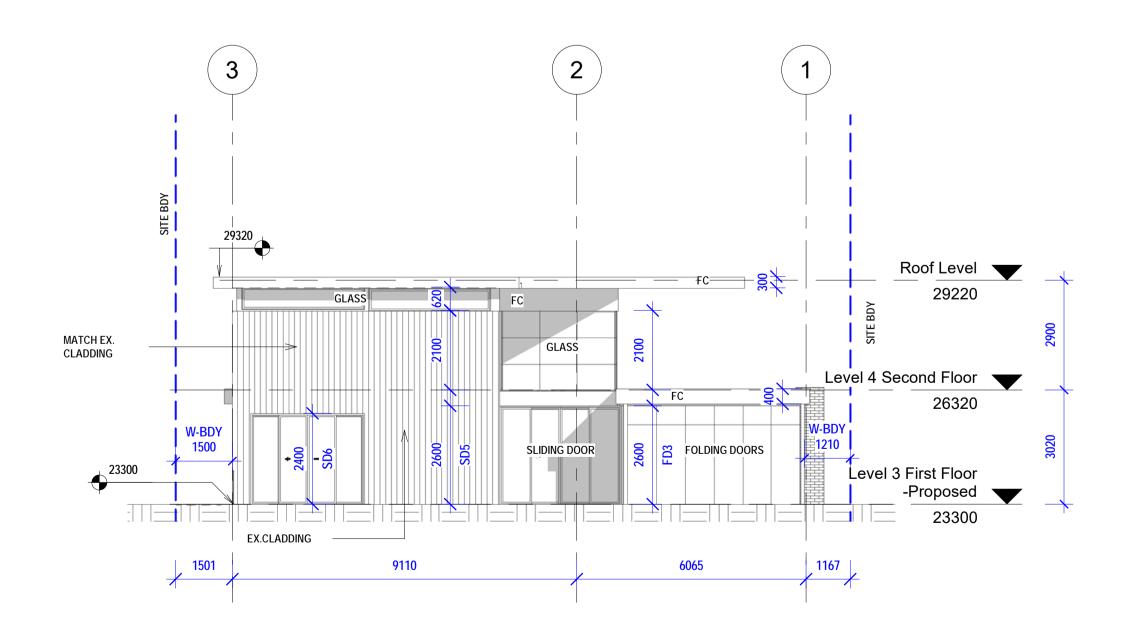
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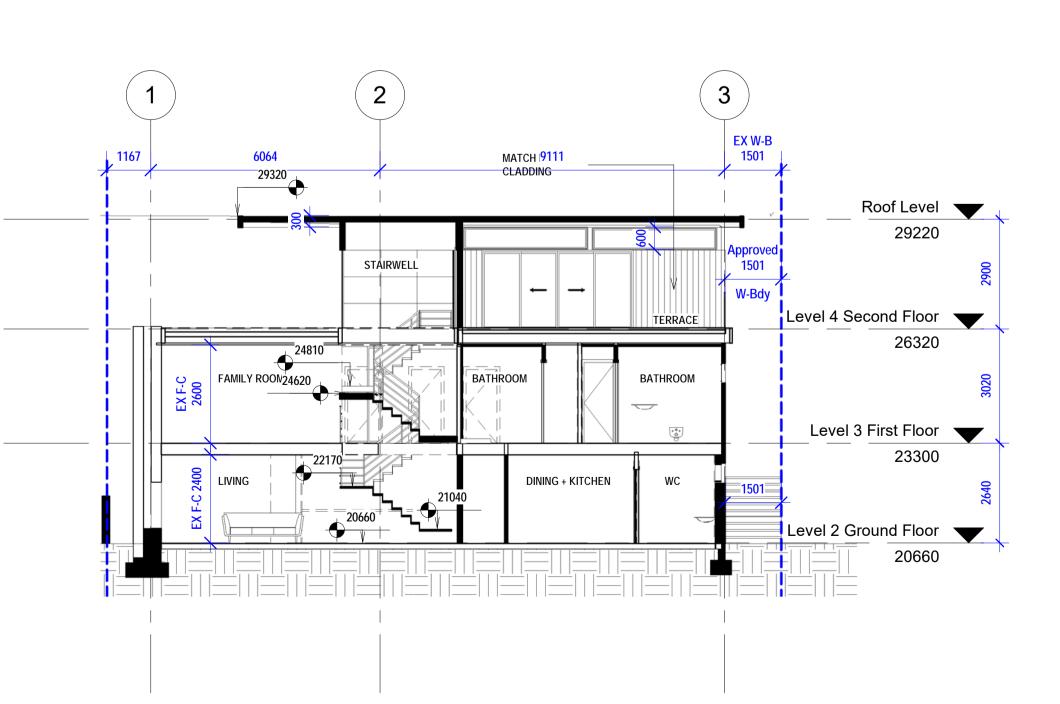
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Northern Elevation - Approved







Section 1 - Approved

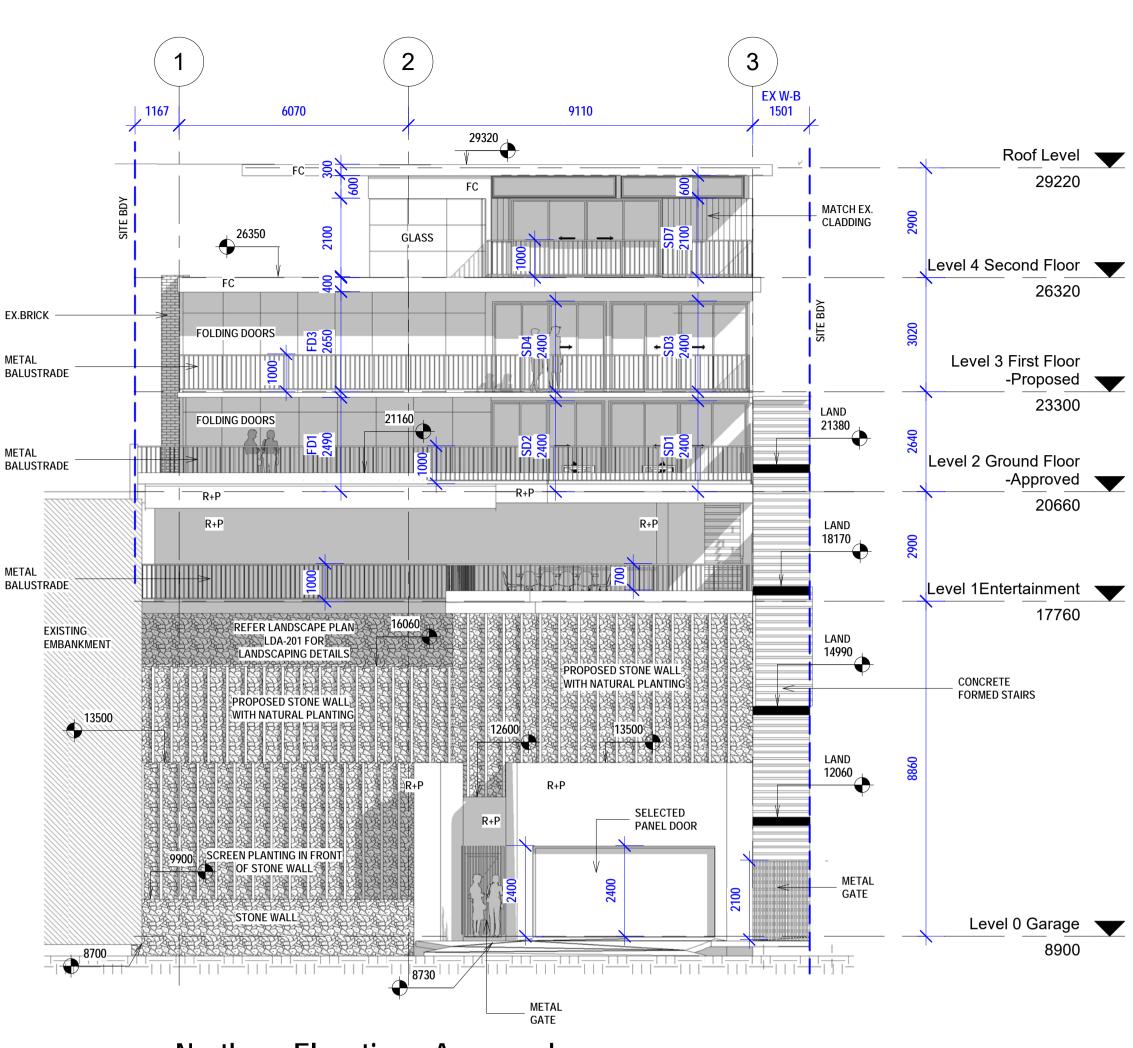DEVELOPMENT APPLICATION

CLIENT

Mr Stephen J. Urch

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TOWN PLANNER QUE CONSULTING T - 1300 123 783 STRUCTURAL ENGINEERS

M - 0434 284 585

LEGEND:

A/C AIR CONDITIONER AHD AUSTRALIAN HEIGHT DATUM

NTIMA CONSULTING PTY LTD

AW ALUMINIUM WINDOW BAL BALUSTRADE

DP DOWNPIPE DPC DAMP PROOF COURSE

(E) EXISTING EQ EQUAL

FCL FINISHED CEILING LEVEL FFL FINISHED FLOOR LEVEL

(N) NEW RL RELATIVE LEVEL RWH RAIN WATER HEAD SKL SKYLIGHT

TBC TO BE CONFIRMED TME TO MATCH EXISTING

TW TIMBER WINDOW VOS VERIFY ON SITE AL ALUMINIUM

BK BRICK GAL GALVANISED GD GLASS DOOR

MRS METAL ROOF SHEETING P PAINT PBD PLASTERBOARD

RC REINFORCED CONCRETE ST STONE

SST SANDSTONE T TIMBER TB TIMBER BATTENS TD TIMBER DOOR

TL TILE TL/SL TILE SLATE ROOF W WINDOW

WB WEATHERBOARD WC WATER CLOSET (TOILET)

DEVELOPMENT APPLICATION: PROPOSED POOL & PLANT ROOM ADDED

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ISSUE AMMENDMENT DATE

Project:

12 Riverview Road NSW **Earlwood** LOT B. DP 420152

Approved Elevations + Section

Project number **5743**

15-09-22

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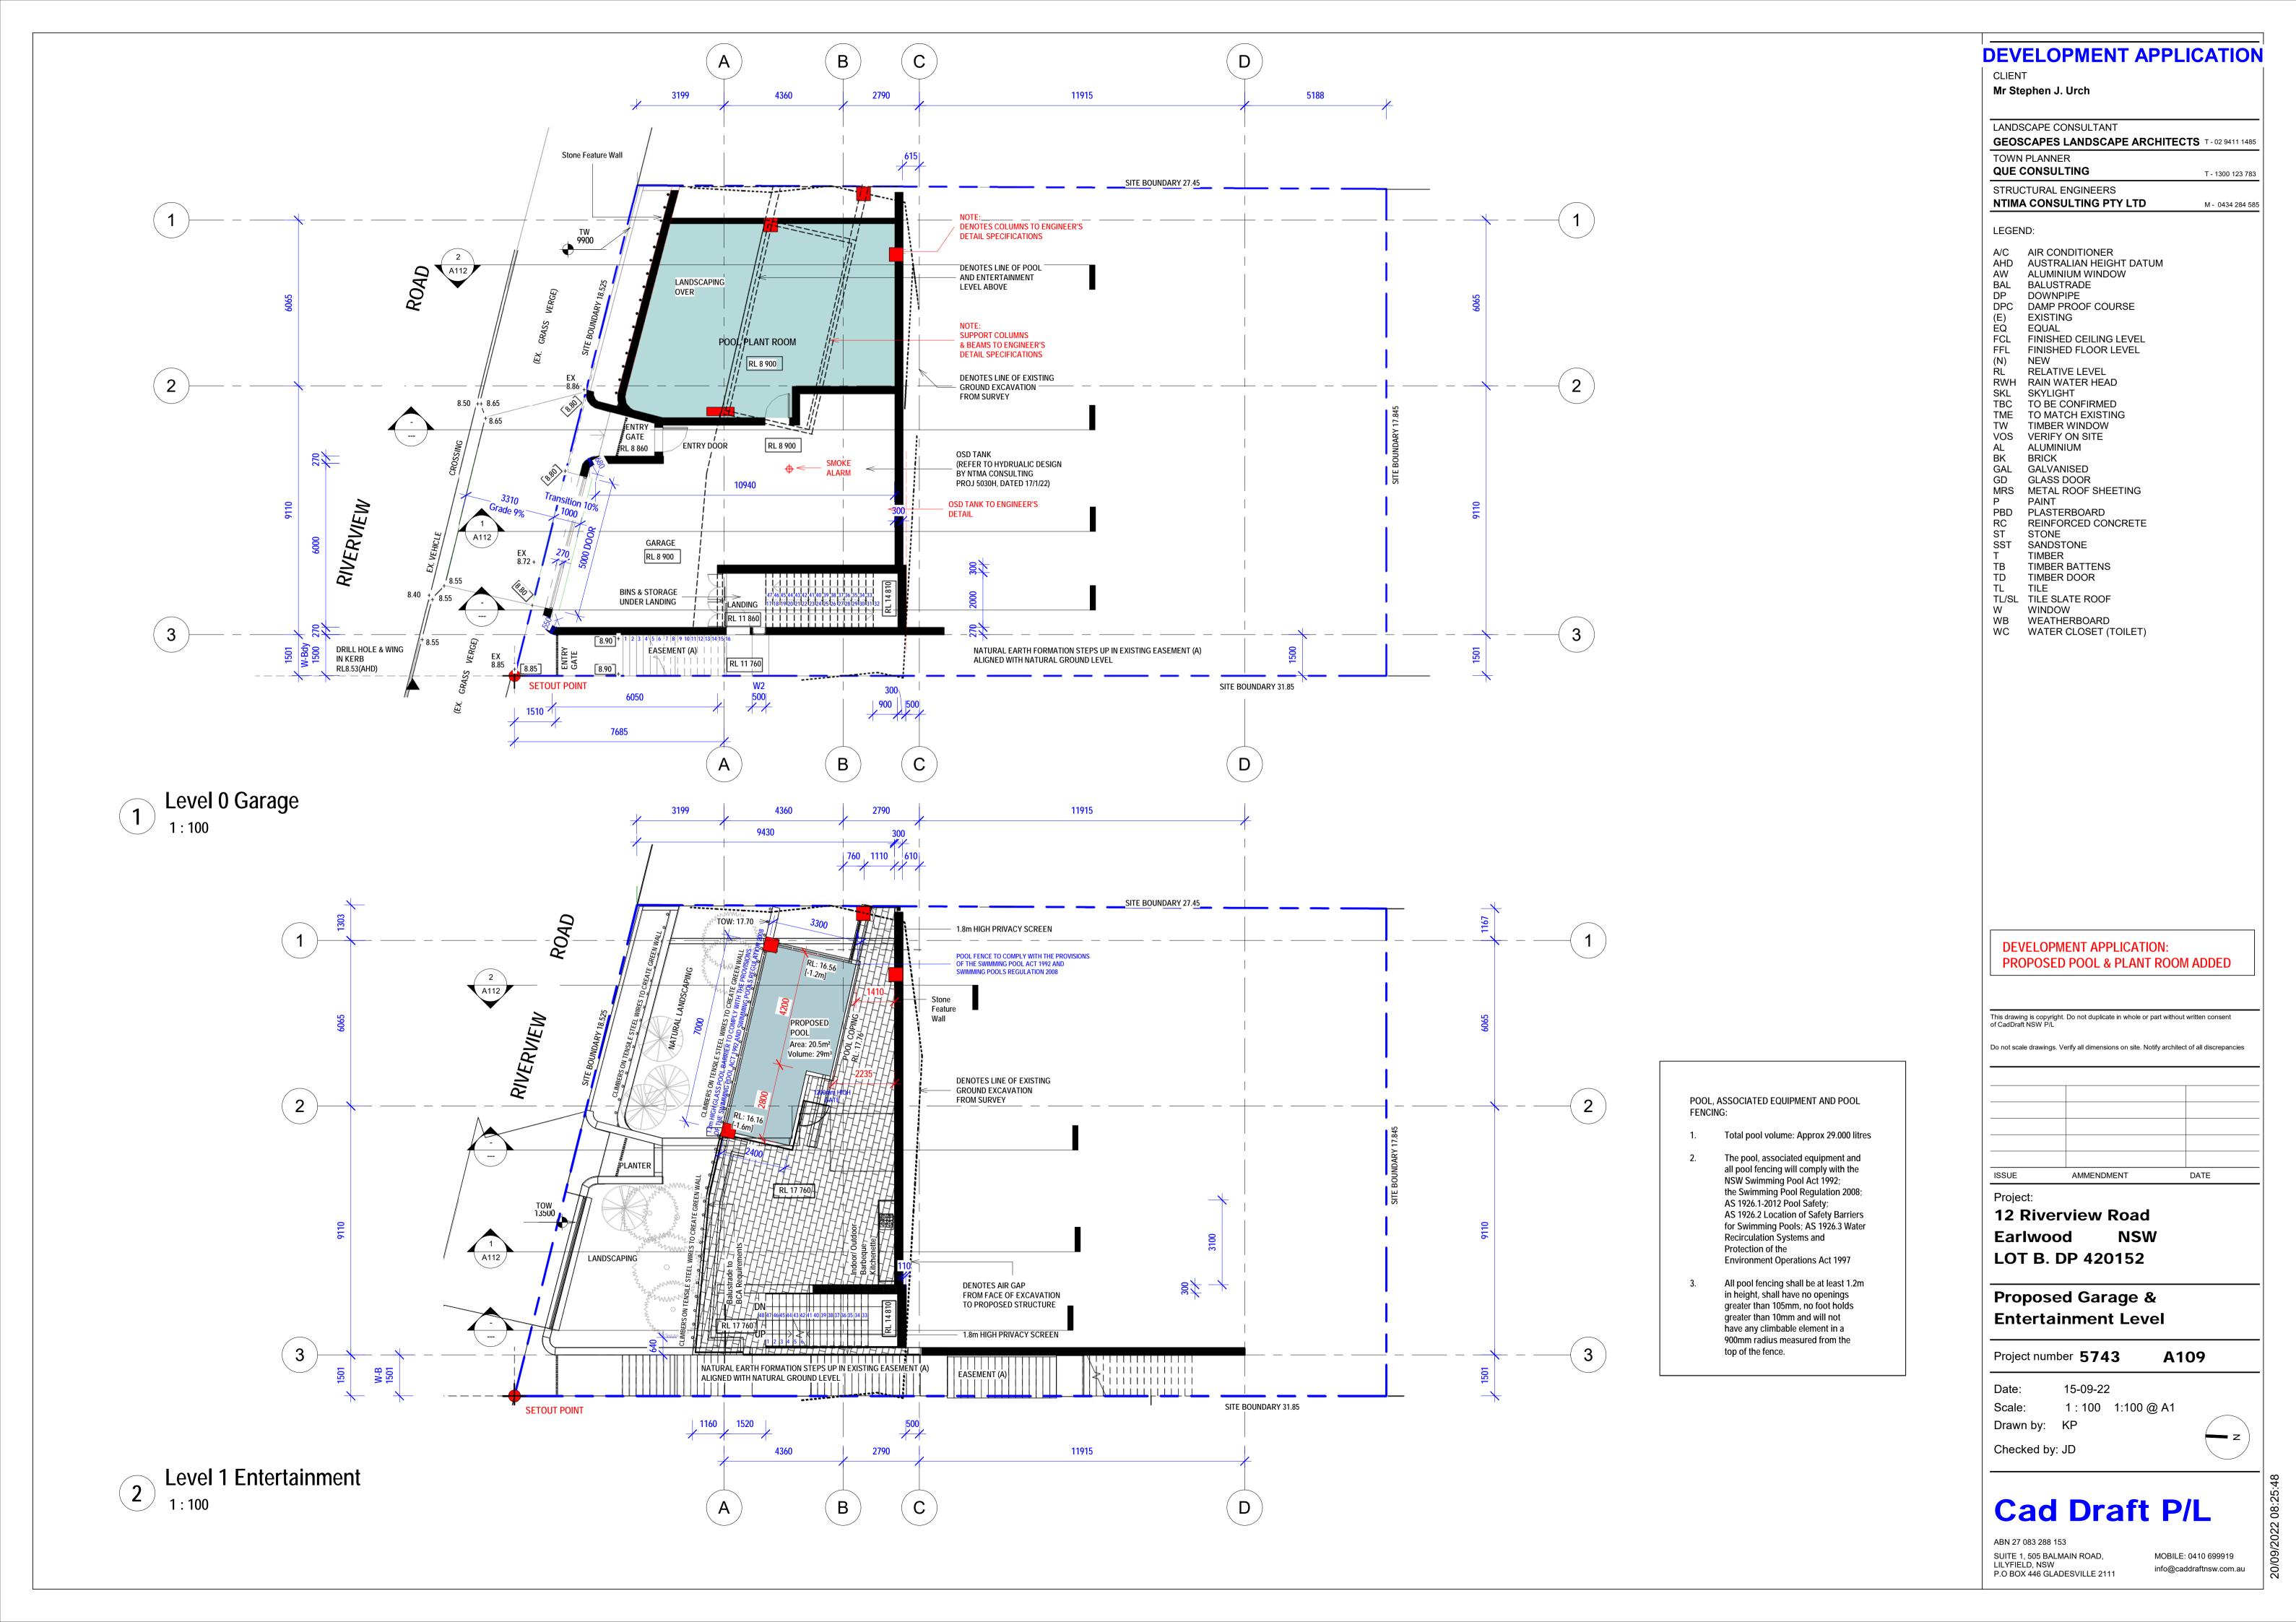
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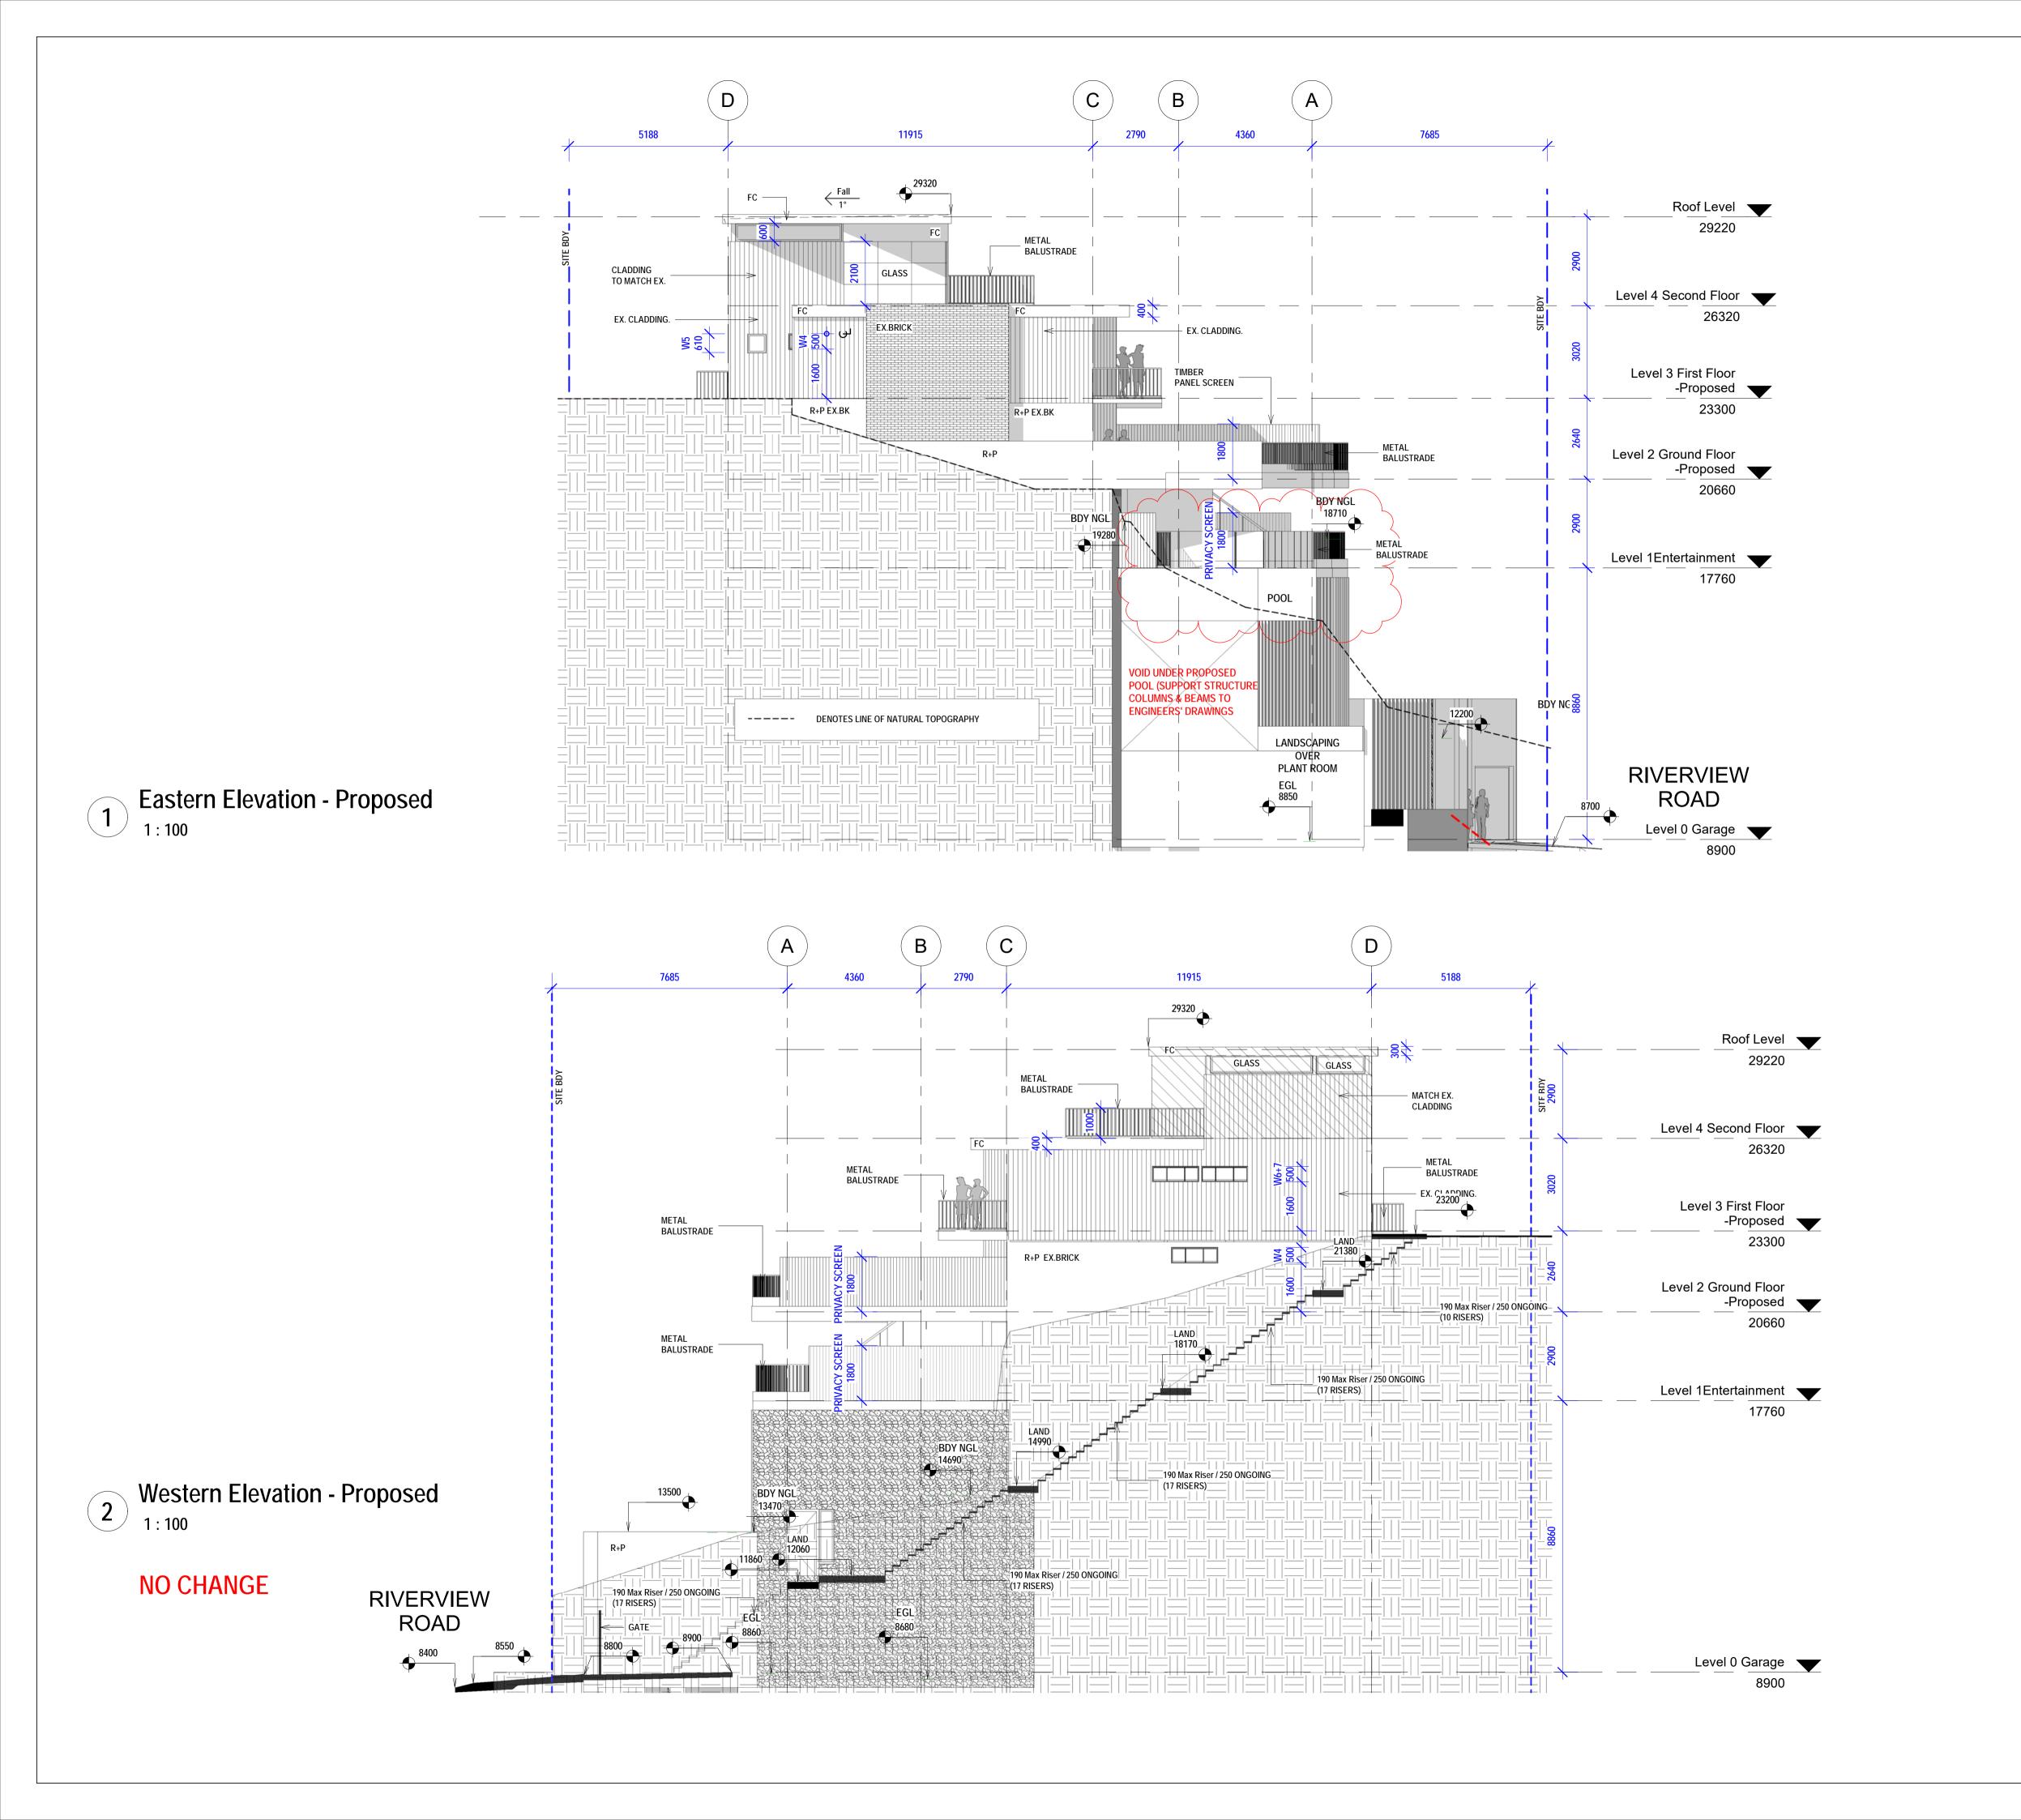
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CLIENT

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M - 0434 284 585

STRUCTURAL ENGINEERS NTIMA CONSULTING PTY LTD

LEGEND:

A/C AIR CONDITIONER AHD AUSTRALIAN HEIGHT DATUM

AW ALUMINIUM WINDOW BAL BALUSTRADE

DP DOWNPIPE

DPC DAMP PROOF COURSE

(E) EXISTING ÈQ EQUAL

FCL FINISHED CEILING LEVEL FFL FINISHED FLOOR LEVEL

(N) NEW RL RELATIVE LEVEL

RWH RAIN WATER HEAD SKL SKYLIGHT

TBC TO BE CONFIRMED TME TO MATCH EXISTING

TW TIMBER WINDOW

VOS VERIFY ON SITE AL ALUMINIUM BK BRICK

GAL GALVANISED GD GLASS DOOR

MRS METAL ROOF SHEETING

P PAINT PBD PLASTERBOARD

RC REINFORCED CONCRETE

ST STONE SST SANDSTONE

T TIMBER TB TIMBER BATTENS

TD TIMBER DOOR TL TILE

TL/SL TILE SLATE ROOF W WINDOW

WB WEATHERBOARD

WC WATER CLOSET (TOILET)

DEVELOPMENT APPLICATION:

PROPOSED POOL & PLANT ROOM ADDED

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Do not scale drawings. Verify all dimensions on site. Notify architect of all discrepancies

ISSUE AMMENDMENT DATE

Project:

12 Riverview Road NSW **Earlwood LOT B. DP 420152**

Eastern + Western Elevations

Project number **5743**

15-09-22

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Drawn by: KP


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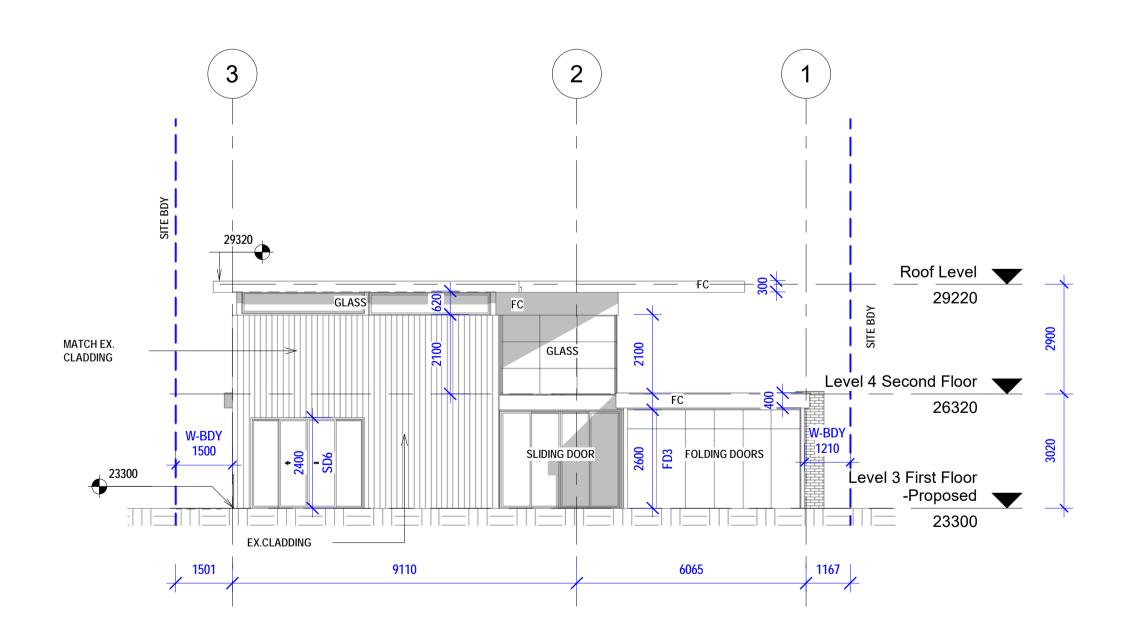


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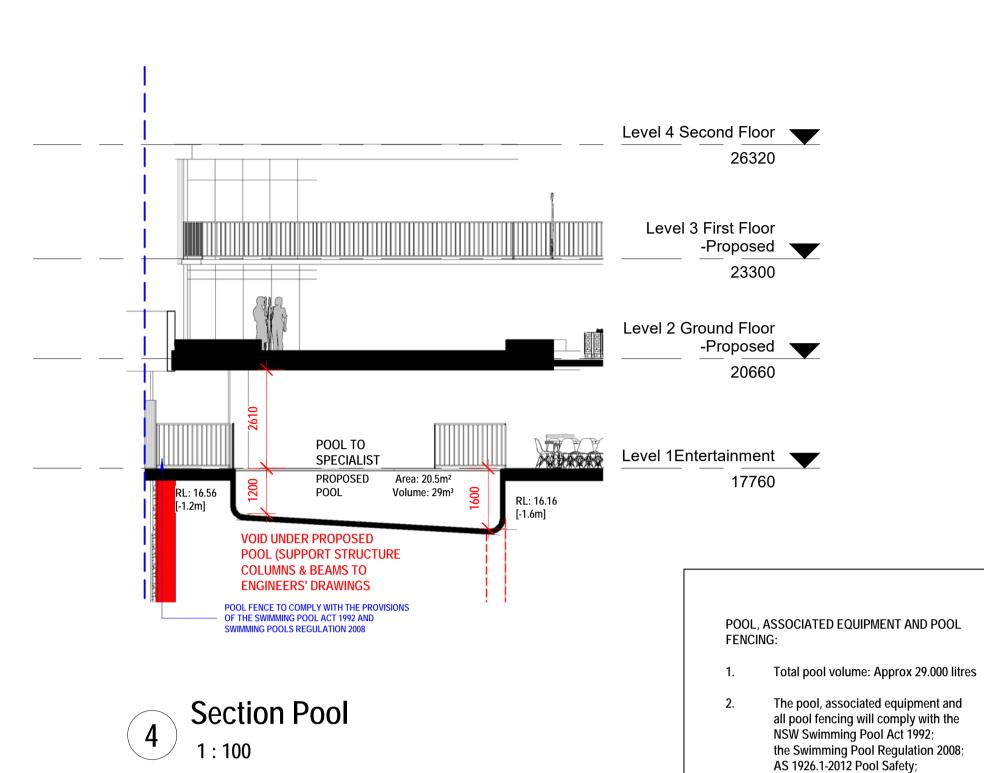
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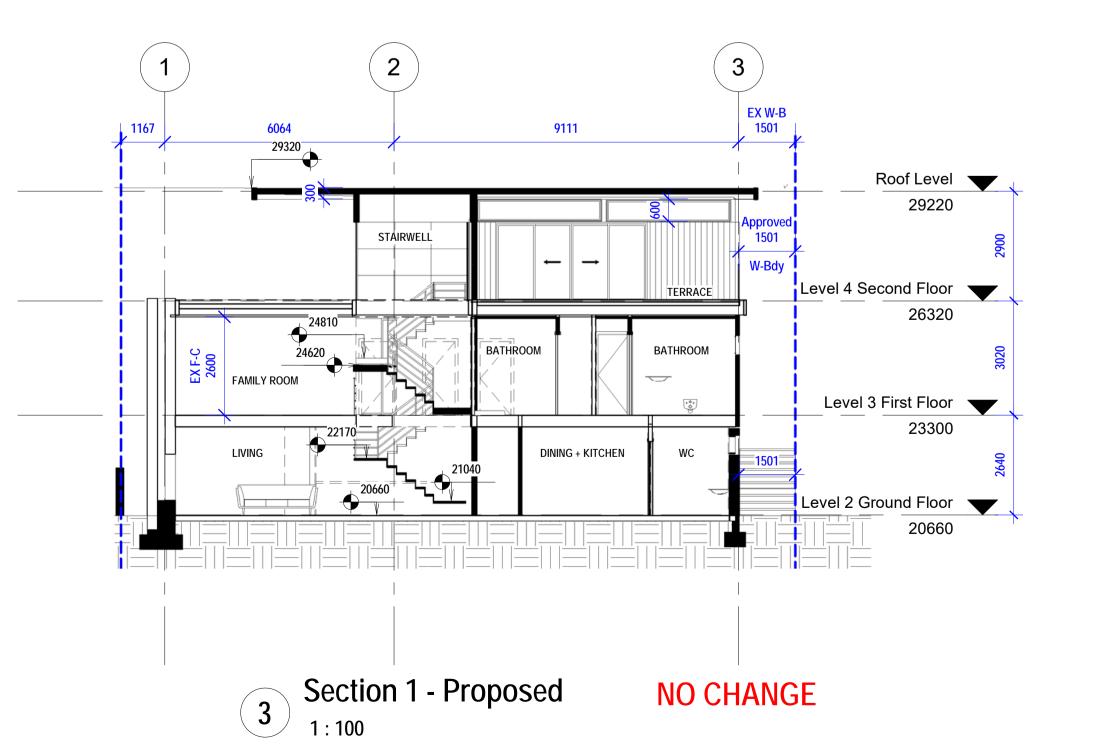




Southern Elevation - Proposed

NO CHANGE

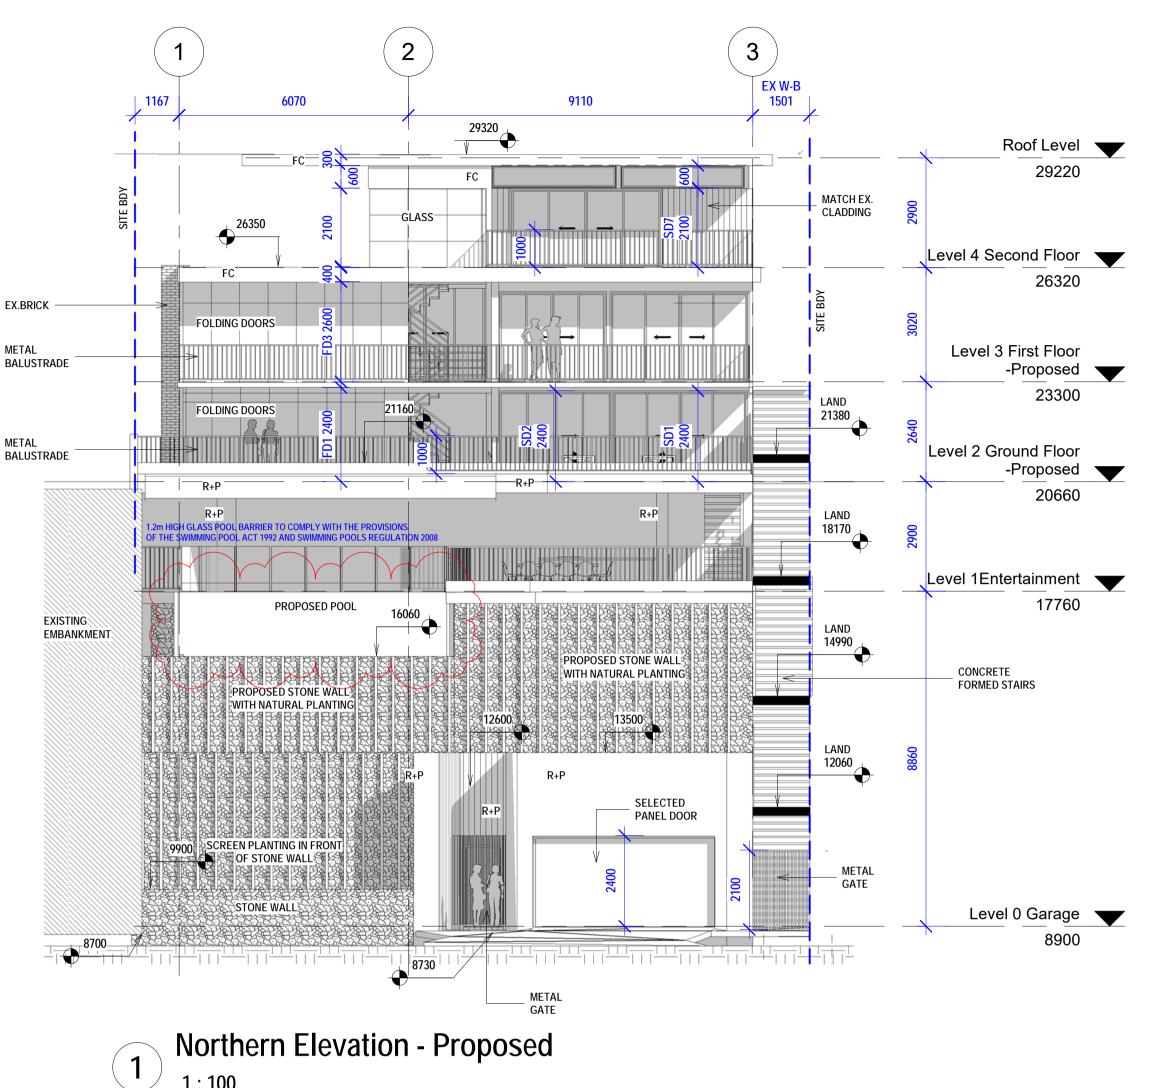



DEVELOPMENT APPLICATION

CLIENT

Mr Stephen J. Urch

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STRUCTURAL ENGINEERS NTIMA CONSULTING PTY LTD M - 0434 284 585

LEGEND:

A/C AIR CONDITIONER AHD AUSTRALIAN HEIGHT DATUM

AW ALUMINIUM WINDOW BAL BALUSTRADE

DP DOWNPIPE

DPC DAMP PROOF COURSE

(E) EQ **EXISTING EQUAL**

FCL FINISHED CEILING LEVEL

FFL FINISHED FLOOR LEVEL (N) NEW RL RELATIVE LEVEL

RWH RAIN WATER HEAD SKL SKYLIGHT

TBC TO BE CONFIRMED TME TO MATCH EXISTING

TW TIMBER WINDOW VOS VERIFY ON SITE

ALUMINIUM BK **BRICK** GAL GALVANISED

GD GLASS DOOR MRS METAL ROOF SHEETING

P PAINT PBD PLASTERBOARD
RC REINFORCED CONCRETE
ST STONE

SST SANDSTONE TIMBER

TIMBER BATTENS TB TIMBER DOOR TD

TL TILE TL/SL TILE SLATE ROOF W WINDOW

WB WEATHERBOARD

WC WATER CLOSET (TOILET)

AS 1926.2 Location of Safety Barriers

for Swimming Pools; AS 1926.3 Water

Environment Operations Act 1997

in height, shall have no openings greater than 105mm, no foot holds

greater than 10mm and will not have any climbable element in a 900mm radius measured from the

Recirculation Systems and

3. All pool fencing shall be at least 1.2m

Protection of the

top of the fence.

DEVELOPMENT APPLICATION: PROPOSED POOL & PLANT ROOM ADDED

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Do not scale drawings. Verify all dimensions on site. Notify architect of all discrepancies

AMMENDMENT ISSUE DATE

Project:

12 Riverview Road NSW **Earlwood LOT B. DP 420152**

Elevations + Sections

Project number **5743**

15-09-22

1:100 1:100 @ A1 Scale: Drawn by: KP


Checked by: JD



ABN 27 083 288 153 SUITE 1, 505 BALMAIN ROAD, LILYFIELD, NSW

P.O BOX 446 GLADESVILLE 2111

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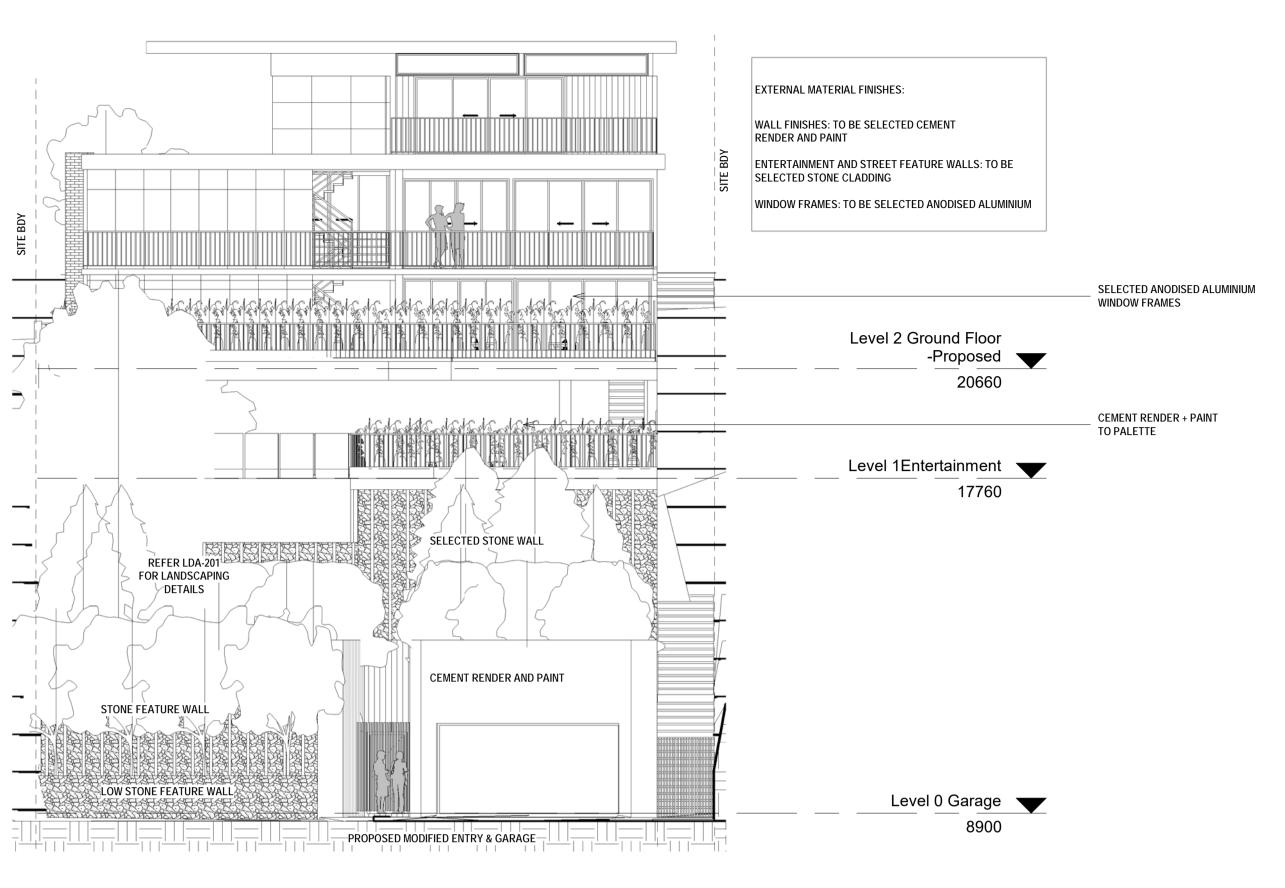


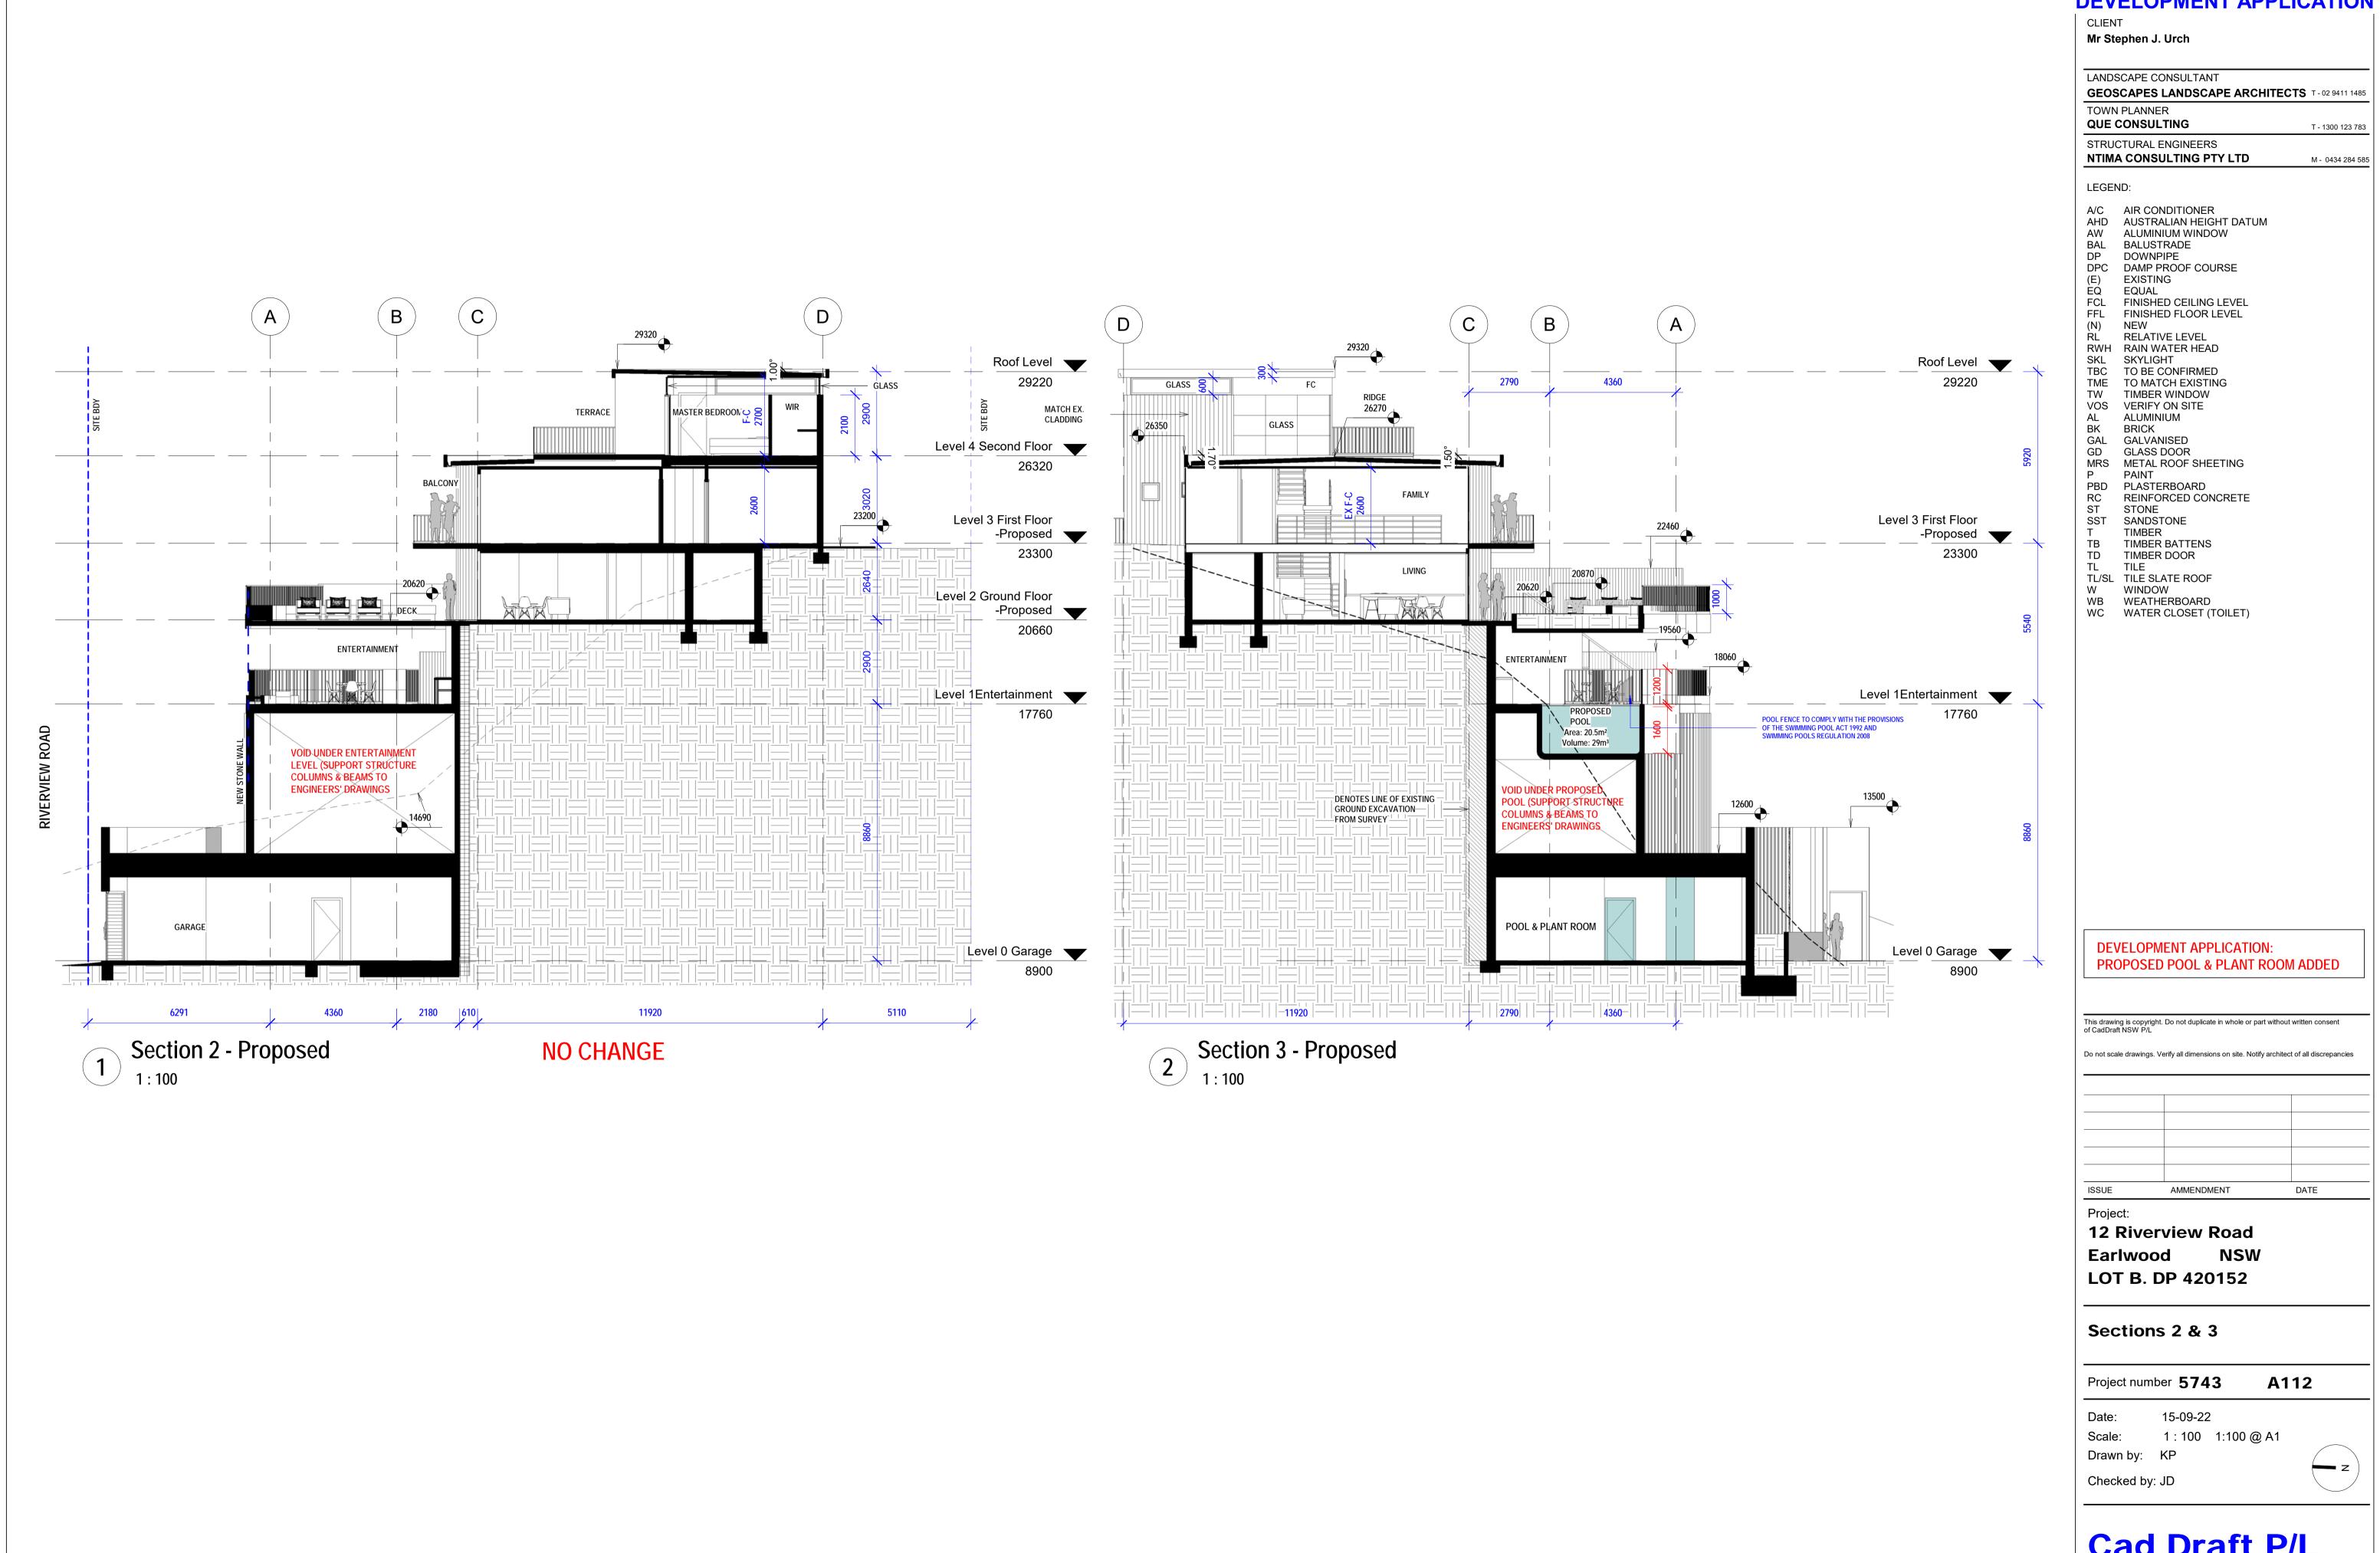Cad Draft P/L


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External Material Finishes



SELECTED COLOUR PALETTE



SELECTED FEATURE STONE

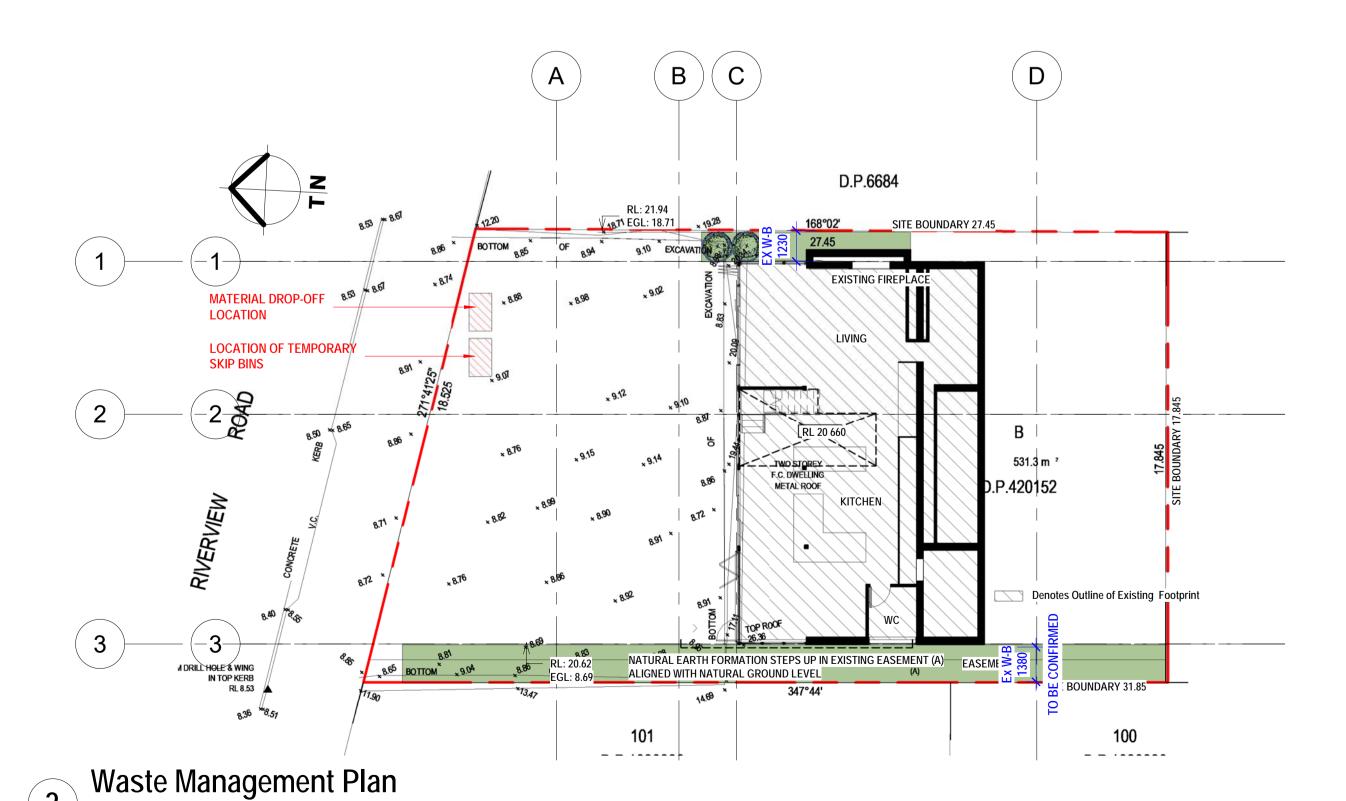NOTES: SITE / WASTE MANAGEMENT

- ALL EROSION AND SEDIMENT CONTROL MEASURES TO BE INSPECTED AND
- MAINTAINED DAILY BY SITE MANAGER
- MINIMISE DISTURBED AREAS
- ALL STOCKPILES TO BE CLEAR FROM DRAINS, GUTTERS AND FOOTPATHS DRAINAGE IS TO BE CONNECTED TO STORMWATER SYSTEM AS SOON AS POSSIBLE
- ROADS AND FOOTPATHS TO BE SWEPT DAILY
- NO MATERIAL TO BE STORED ON FOOTPATH IF YOU DO NOT COMPLY YOU MAY BE LIABLE TO A FINE

DEVELOPMENT APPLICATION

Mr Stephen J. Urch

LANDSCAPE CONSULTANT

GEOSCAPES LANDSCAPE ARCHITECTS T - 02 9411 1485

TOWN PLANNER QUE CONSULTING T - 1300 123 783 STRUCTURAL ENGINEERS

M - 0434 284 585

LEGEND:

A/C AIR CONDITIONER AHD AUSTRALIAN HEIGHT DATUM

NTIMA CONSULTING PTY LTD

AW ALUMINIUM WINDOW BAL BALUSTRADE

DP DOWNPIPE

DPC DAMP PROOF COURSE

(E) EXISTING

ÈQ EQUAL

FCL FINISHED CEILING LEVEL FFL FINISHED FLOOR LEVEL

(N) NEW RL RELATIVE LEVEL

RWH RAIN WATER HEAD

SKL SKYLIGHT TBC TO BE CONFIRMED

TME TO MATCH EXISTING TW TIMBER WINDOW

VOS VERIFY ON SITE

ALUMINIUM BK BRICK

GAL GALVANISED

GD GLASS DOOR MRS METAL ROOF SHEETING

P PAINT

PBD PLASTERBOARD

RC REINFORCED CONCRETE ST STONE

SST SANDSTONE T TIMBER

TB TIMBER BATTENS

TD TIMBER DOOR TL TILE

TL/SL TILE SLATE ROOF

W WINDOW WB WEATHERBOARD WC WATER CLOSET (TOILET)

EXTERNAL MATERIAL FINISHES:

WALL FINISHES: TO BE SELECTED CEMENT RENDER AND PAINT

POOL AND STREET FEATURE WALLS: TO BE SELECTED STONE CLADDING

WINDOW FRAMES: TO BE SELECTED ANODISED ALUMINIUM

DEVELOPMENT APPLICATION: PROPOSED POOL & PLANT ROOM ADDED

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AMMENDMENT ISSUE

NSW **Earlwood LOT B. DP 420152**

12 Riverview Road

External Finishes + Waste Management Plan

Project number **5743**

15-09-22

As indicated 1:100 @ A1

Scale: Drawn by: KP

Checked by: JD

Project:

Cad Draft P/L


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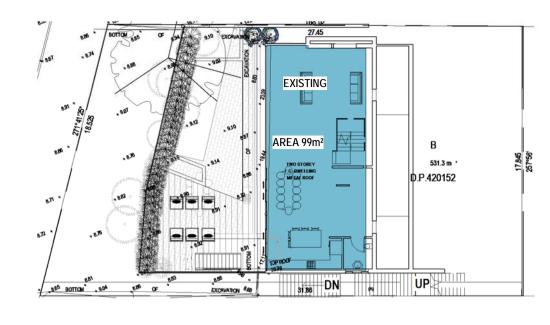
MOBILE: 0410 699919 info@caddraftnsw.com.au

A113

DATE






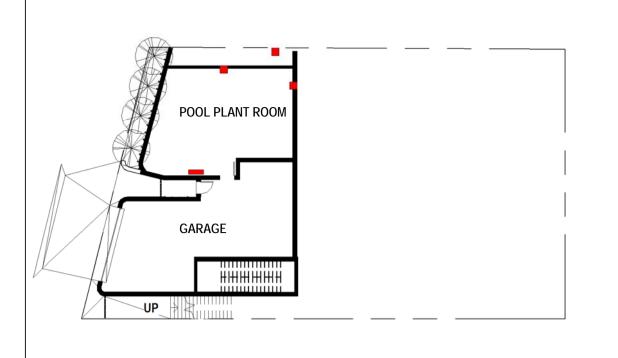


2 Level 2 Ground Floor -Approved



Level 3 First Floor -Approved

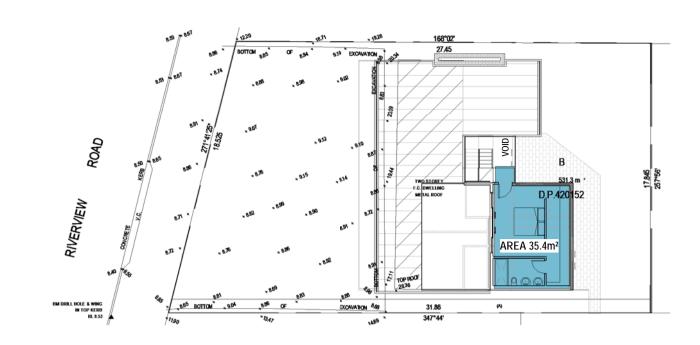

Level 4 Second Floor - Approved

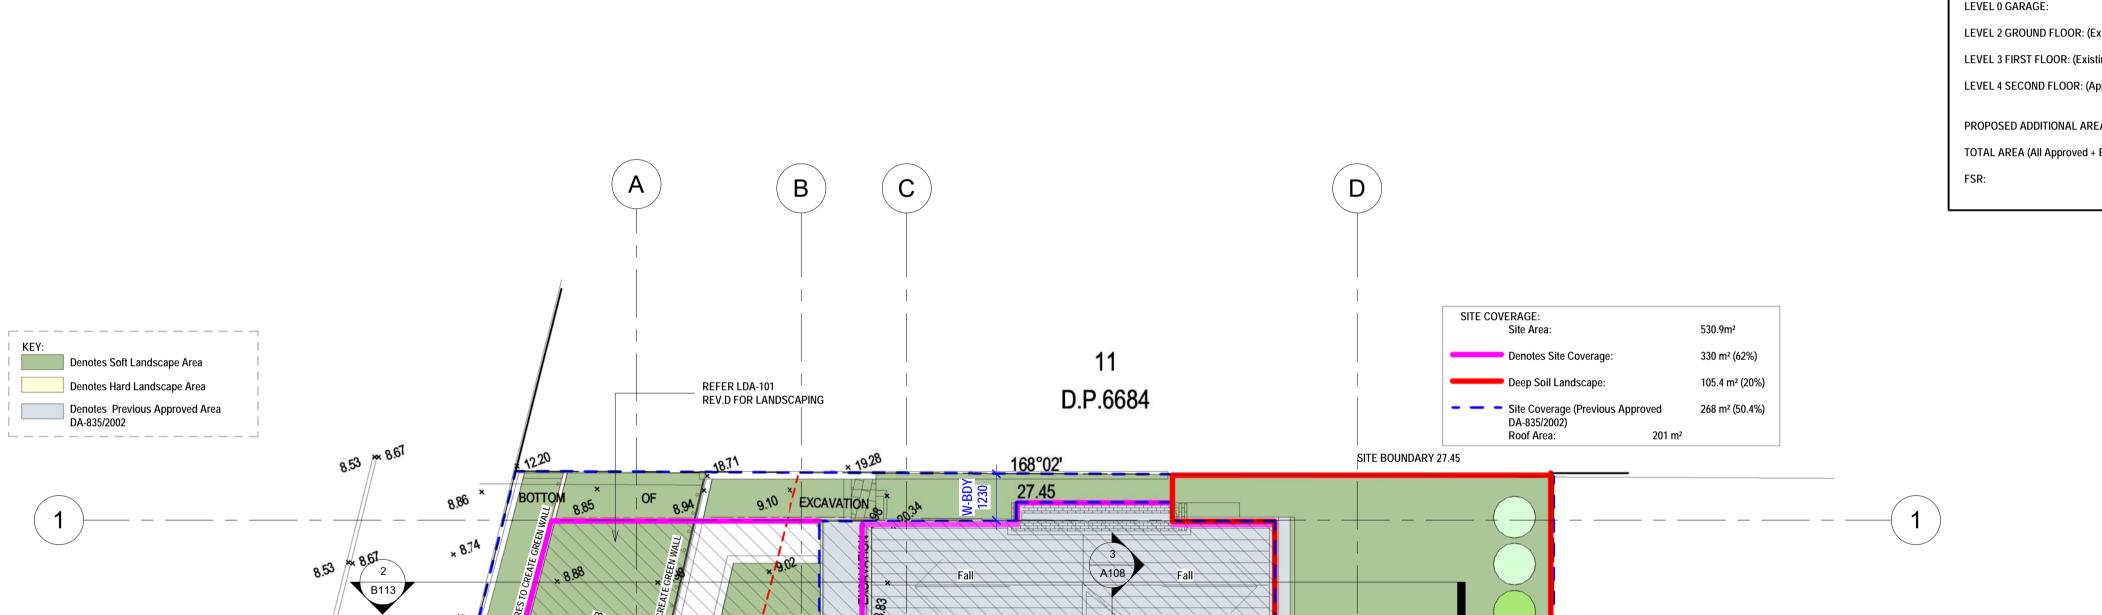

80	Previous Approved Landscaped Area to Deck DA-835/2002 Previous Area to Deck DA-835/2		RL 23 300 EXISTING LANDSCAPING	
8.50 8.86	No 14 Setback 8 9 9 1 1 1 1 1 1 1 1 1 1 1 1 1 1 1 1 1	TWO STOREY F.C. DWELLING MNO 12 RIVERVIEW ROAD D.P.42	17.845 0.670 F.01	A D.P.420152
RIVERVIEW CONGRETE CONGRETE RIVERVIEW ** ** ** ** ** ** ** ** **	7330 RL 20 620 RL 12 600 RL 12 600 RL 20 620	RL 26 320	EXISTING TILES	
BM DRILL HOLE & WING IN TOP KERB RL 8.53	BOTTOM × 9.04 \$ 50 OF ALIGNED WITH NATURAL GROUND STATE OF ALIGNED WITH THE ALIG	× 247944'	DARY 31.85	<u></u>
Site Coverage + Deep Soil Pl	WORKS	PREVIOUS APPROVED WORKS	D	

FLOOR SPACE AREA CALCULATIONS: SITE AREA: 530.9 m² LEVEL 0 GARAGE: 0 m² LEVEL 2 GROUND FLOOR: (Existing + Approved) 99 m² LEVEL 3 FIRST FLOOR: (Existing + Approved) 132 m² LEVEL 4 SECOND FLOOR: (Approved) 35.4 m² PROPOSED ADDITIONAL AREA: 0 m² TOTAL AREA (All Approved + Existing): 266.4 m² 0.50:1

DEVELOPMENT APPLICATION: PROPOSED POOL & PLANT ROOM ADDED

DEVELOPMENT APPLICATION

GEOSCAPES LANDSCAPE ARCHITECTS T - 02 9411 1485

T - 1300 123 783

M - 0434 284 585

CLIENT

Mr Stephen J. Urch

TOWN PLANNER **QUE CONSULTING**

LEGEND:

BAL

(E) EQ

(N) RL

LANDSCAPE CONSULTANT

STRUCTURAL ENGINEERS

A/C AIR CONDITIONER

BALUSTRADE DP DOWNPIPE DPC DAMP PROOF COURSE

FCL FINISHED CEILING LEVEL FINISHED FLOOR LEVEL

RELATIVE LEVEL RWH RAIN WATER HEAD

TBC TO BE CONFIRMED TME TO MATCH EXISTING TW TIMBER WINDOW VOS VERIFY ON SITE

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P PAINT

TL TILE

W WINDOW

NTIMA CONSULTING PTY LTD

AHD AUSTRALIAN HEIGHT DATUM ALUMINIUM WINDOW

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AMMENDMENT

NSW Earlwood **LOT B. DP 420152**

12 Riverview Road

FSR + Site Areas Calculations

A114

Project number **5743**

15-09-22

Scale: As indicated 1:100 @ A1

Drawn by: KP Checked by: JD

Project:



ABN 27 083 288 153

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